BOARD OF ADJUSTMENT - APPLICATION FOR CONDITIONAL USE PERMIT (Communication Antenna or Tower or Wind Energy Conversion System)

TO:

Board of Adjustment

Community Development Department

City Hall, 701 E. Broadway, Columbia, Missouri 65201

SUBJECT:

Notice of application in regard to the following described property located in the

City of Columbia, County of Boone, State of Missouri (legal description):

See Legal Description attached to this Application for Conditional Use Permit as Exhibit A.

Which is presently zoned <u>PD Planned Development</u> and known, or to be known, as <u>1205 W.</u> <u>Broadway Street</u>, <u>Columbia</u>, <u>Missouri 65203</u> (Street Number and Name)

County Assessor's 14 Digit Real Estate Tax Number: 163170016009001

Notice is hereby given that Applicant(s) hereby applies to the Board of Adjustment of the City of Columbia, Missouri for a Conditional Use Permit to make the following use of the above described property (attached additional pages for response or separate letter detailing desired use of property):

Applicant SBA Towers II LLC submits this CUP Application seeking to modify its existing 110-foot-tall cell tower, which was approved by the City pursuant to CUP issued in 2012 and is located on the property identified above, from a stealth design to a monopole design, as for fully explained in the exhibits attached hereto.

The Board of Adjustment is authorized to grant said permit in accordance with the use-specific standards established in Section 29-3.3 and 29-6.4(m)(2)(i) and (ii), as applicable. City of Columbia Code of Ordinances. The applicant hereby acknowledges reading Section 29-6.4(m) and providing supplemental documentation to completely answer the "Criteria for Approval" questions of said section, as applicable, and further understands failure to provide responses to said questions may constitute an incomplete application or result in Board denial of the application.

Applicant(s) requests that a Certificate of Decision granting a Conditional Use Permit be issued by the Board of Adjustment.

September 26, 2025

SIGNATURE(S)

DATE

PRINTED NAME: Zachary T. Buchheit, Attorney at Stinson LLP ADDRESS: 7700 Forsyth Blvd., Suite 1100, St. Louis, MO 63015

TELEPHONE: 314-345-7038

CAPACITY OR INTEREST IN PROPERTY: <u>Applicant SBA Towers II LLC is a lessee of the property from landowner Broadway Office Park Condominium Association, as demonstrated by the documents attached hereto as Exhibits B, C, and D.</u>

This application is hereby acknowledged as being received for Board of Adjustment consideration by:


COMMUNITY DEVELOPMENT DIRECTOR OR DESIGNEE

DATE 9/39/2025

Summary of the Modification Requested in this CUP Application:


This CUP application is not for construction of a new cell tower, but instead is for the modification of an existing 110-foot-tall tower to convert it from a stealth design to a monopole design. The existing tower was approved by the City pursuant to a CUP issued on September 11, 2012. On the existing tower, T-Mobile is mounted at 85 feet and AT&T is mounted at 106 feet, and there is availability for additional equipment to be mounted at 75 feet and also 96 feet. These mounting heights and collocation abilities will not change with the requested modification, so this tower provides four (4) antenna arrays.

The location and height (among other things) of the tower will not change as part of this modification. Instead, the modification will involve removal of the top three canisters and all internal equipment from 80 feet to 110 feet on the existing tower, and replacement of this 30-foot area with a new monopole section. A new platform extending less than 20 feet horizontally (less than 10 feet on each side of the monopole) will be installed at the 85-foot-mark to support T-Mobile equipment, along with six antennas and six remote radio units on the platform, matching existing T-Mobile antenna elevation. Additionally, all existing AT&T equipment at the 106-foot-mark will be removed and replaced with flush mounted equipment at this same height. All cabling will be routed inside the new monopole structure. These modifications from the 80-foot-mark to the 110-foot-mark on the existing tower are reflected in the design drawing pasted below:

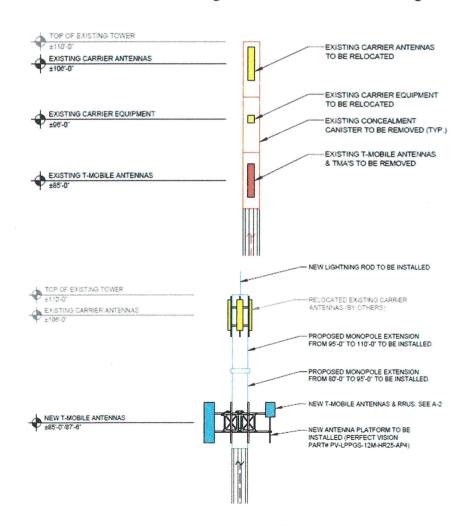

Page 1 of 7

As for the equipment installed on the ground as part of the modification, all such equipment will remain within the existing compound area. There currently are two cabinets installed in the compound. One of those two cabinets will be removed and replaced with a cabinet similar in appearance and size to the other existing cabinet, which will remain unchanged. The new cabinets, like the existing cabinets, comply with the Code's size requirements. Additionally, the existing power plant controller will be replaced with a similar unit either of the same size or only negligibly larger. Additionally, two ice bridges will be installed over the ground equipment as part of this modification, with each being a maximum height of 10-feet-tall and depicted in the design drawings pasted below:

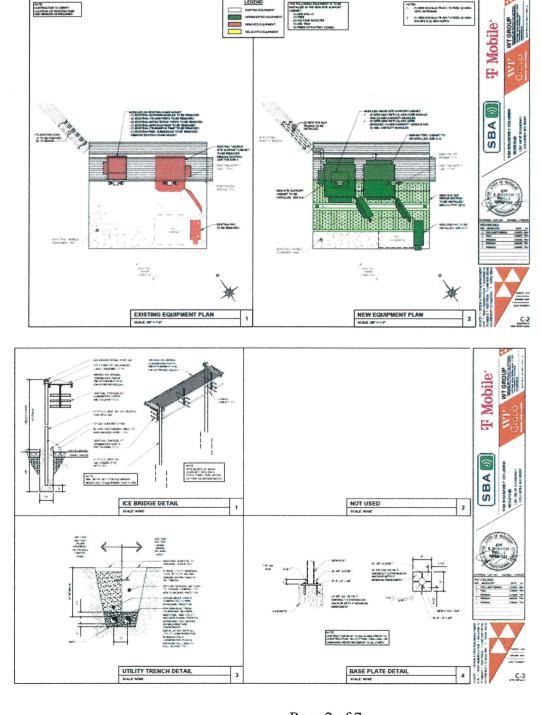

Page 2 of 7

Explanation of Reason for the Modification Requested in this CUP Application:

T-Mobile is not able to provide Ultra Capacity 5G coverage from the existing stealth-designed tower based on equipment limitations in stealth towers. But T-Mobile will be able to provide Ultra Capacity 5G coverage from the modified monopole-designed tower. So this requested modification and conversion is necessary to support T-Mobile's equipment and technologies to add Ultra Capacity 5G to the surrounding area, which will increase T-Mobile's coverage and speed and improve the connection for the community and the residents in the surrounding area, which in turn improves the quality of life for the surrounding subdivisions and the commercial areas nearby, including restaurants and businesses such as Anytime Fitness, Gerbes Bakery and Deli, Shelter Insurance, ARC Activity and Recreation Center, Cleek's Home Furnishings, and Columbia/Boone County Public Health and Human Services.

Modification Requested Is Not Uncommon:

In June 2024, SBA successfully completed the conversion of a stealth canister tower to a full monopole tower with exterior mounts on the University of Missouri's nearby campus. The University was fully supportive of the tower enhancements and promptly approved the conversion.

Restrictions Imposed on Zoning Authorities by Mo. Rev. Stat. § 67.5094:

In 2014, the Missouri Legislature enacted Mo. Rev. Stat. § 67.5094 as part of its passage into law of the Uniform Wireless Communications Infrastructure Deployment Act. Mo. Rev. Stat. § 67.5094 specifically prohibits local zoning authorities, such as the City of Columbia, from requiring or considering certain information or documents as part of a CUP application for a new or modified cell tower. In pertinent part related to SBA's CUP application, Mo. Rev. Stat. § 67.5094 states as follows:

In order to ensure uniformity across the state of Missouri with respect to the consideration of every application, an authority shall not:

- (1) Require an applicant to submit information about, or evaluate an applicant's business decisions with respect to its designed service, customer demand for service, or quality of its service to or from a particular area or site;
- (2) Evaluate an application based on the availability of other potential locations for the placement of wireless support structures or wireless facilities, including without limitation the option to collocate instead of construct a new wireless support structure or for substantial modifications of a support structure, or vice versa; provided, however, that solely with respect to an application for a new wireless support structure, an authority may require an applicant to state in such applicant's application that it conducted an analysis of available collocation opportunities on existing wireless towers within the same search ring defined by the applicant, solely for the purpose of confirming that an applicant undertook such an analysis; for collocation to any certified historic structure as defined in section 253.545, in addition to all other applicable time requirements, there shall be a thirty-day time period before approval of an application. During such time period, an authority shall hold one or more public hearings on collocation to a certified historic structure;

- (3) Dictate the type of wireless facilities, infrastructure or technology to be used by the applicant, including, but not limited to, requiring an applicant to construct a distributed antenna system in lieu of constructing a new wireless support structure; . . .
- (16) Impose any requirements or obligations regarding the presentation or appearance of facilities, including, but not limited to, those relating to the kind or type of materials used and those relating to arranging, screening, or landscaping of facilities if such regulations or obligations are unreasonable.

Mo. Rev. Stat. § 67.5094(3) and (16) above preclude the City from denying SBA's CUP for a modification of an existing tower from stealth to monopole design, as any such denial would "dictate the type of wireless facilities, infrastructure and technology" used by SBA and would impose unreasonable requirements or obligations on SBA regarding the presentation and appearance of its facilities.

Columbia, Missouri Code of Ordinances Section 29-6.4(m)(2)(i) General Criteria:

SBA submits the following responses to the general criteria identified in Section 29-6.4(m)(2)(i) of the City's Code of Ordinances:

(A) The proposed conditional use complies with all standards and provisions in this chapter applicable to the base and overlay zone district where the property is located;

SBA Response: This tower is located on property zoned PD Planned Development, and it complies with all applicable standards and provisions in the Code of Ordinances. See also Mo. Rev. Stat. § 67.5094(3) and (16) above, which preclude an authority from "dictat[ing] the type of wireless facilities, infrastructure and technology" used by SBA or imposing unreasonable requirements or obligations on SBA regarding the presentation and appearance of its facilities.

(B) The proposed conditional use is consistent with the city's adopted comprehensive plan;

SBA Response: The proposed use aligns with the goals of Columbia Imagined, the City's comprehensive plan, which supports infrastructure improvements that enhance connectivity and public safety. Specifically, among other things, the proposed use furthers the following goal from the comprehensive plan: "Working with communications providers, to install the best wireless and fiber networks and emerging technologies." (See pages 93 (Goal 5) and Page 143 (Policy Two)). The conversion will improve cellular service in the area, supporting both residential and commercial needs, in furtherance of Columbia Imagined. (See Section 1.3 Infrastructure, page 37) (https://www.como.gov/wp-content/uploads/2021/02/ColumbiaImagined-FINAL.pdf)

(C) The proposed conditional use will be in conformance with the character of the adjacent area, within the same zoning district, in which it is located. In making such a determination, consideration may be given to the location, type and height of buildings or structures and the type and extent of landscaping and screening on the site;

SBA Response: The surrounding area includes a mix of residential, commercial, and institutional uses. While the stealth design of the existing tower was originally intended to minimize visual impact, the proposed monopole will be designed with neutral colors and minimal lighting to blend with the environment. Moreover, the location and height of the existing tower, and the landscaping and screening on the site, will not change as part of the conversion from stealth to monopole design.

- (D) Adequate access is provided and is designed to prevent traffic hazards and minimize traffic congestion;
 - SBA Response: Access to the site remains unchanged and is sufficient for maintenance and emergency response of the tower as modified. The conversion will not generate additional traffic, congestion, or traffic hazards, and no modifications to public access routes are required.
- (E) Sufficient infrastructure and services exist to support the proposed use, including, but not limited to, adequate utilities, storm drainage, water, sanitary sewer, electricity, and other infrastructure facilities are provided; and
 - SBA Response: All necessary infrastructure is in place to support the upgraded monopole tower, including utilities, storm drainage, water, sanitary sewer, electricity, and other infrastructure. No additional utility extensions or upgrades are needed.
- (F) The proposed conditional use will not cause significant adverse impacts to surrounding properties.

SBA Response: The proposed conversion from stealth to monopole will not cause significant adverse impacts to surrounding properties. In fact, the upgrade from stealth to monopole design will enhance telecommunications service by allowing carriers on the tower to make new 5G coverage available to the surrounding area (where it is currently unavailable), which is a significant public benefit specific to the surrounding properties.

<u>Columbia, Missouri Code of Ordinances Section 29-6.4(m)(2)(ii) Criteria for Communication Antennas and Towers:</u>

SBA submits the following responses to the criteria for communication antennas and towers identified in Section 29-6.4(m)(2)(ii) of the City's Code of Ordinances:

- (A) Whether or not existing towers are located within the geographic area necessary to meet the applicant's engineering requirements;
 - SBA Response: Mo. Rev. Stat. § 67.5094(1)-(2) precludes the City from requiring SBA to provide the requested information or from evaluating the requested information as part of its consideration of SBA's CUP application. However, SBA and T-Mobile conducted an analysis of potential available collocation opportunities on existing wireless towers within the necessary and applicable coverage area but no

such available towers exist. Moreover, SBA's CUP application seeks to modify and convert an existing stealth tower to a monopole design, so this criteria does not apply.

(B) Whether or not existing towers, structures or buildings within the applicant's required geographic area are of sufficient height to meet system engineering requirements;

SBA Response: Mo. Rev. Stat. § 67.5094(1)-(2) precludes the City from requiring SBA to provide the requested information or from evaluating the requested information as part of its consideration of SBA's CUP application. However, SBA and T-Mobile conducted an analysis of potential available collocation opportunities on existing towers, structures, and buildings within the necessary and applicable coverage area but no such available towers, structures or buildings exist. Moreover, SBA's CUP application seeks to modify and convert an existing stealth tower to a monopole design, so this criteria does not apply.

(C) Whether or not existing towers or structures have sufficient structural strength to support the applicant's proposed antenna;

SBA Response: Mo. Rev. Stat. § 67.5094(1)-(2) precludes the City from requiring SBA to provide the requested information or from evaluating the requested information as part of its consideration of SBA's CUP application. However, SBA and T-Mobile conducted an analysis of potential available collocation opportunities on existing towers and structures within the necessary and applicable coverage area but no such available towers or structures exist. Moreover, SBA's CUP application seeks to modify and convert an existing stealth tower to a monopole design, so this criteria does not apply. In any event, SBA's existing tower has sufficient structural strength to support the proposed modification. See the attached Exhibit/Attachment I, showing a passing structural analysis after the proposed modifications are incorporated.

(D) Whether or not the fees, costs, or other contractual terms required by the owner(s) of existing tower(s), structure(s) or building(s) within the required geographic area of the applicant or to retrofit the existing tower(s) or structure(s) are reasonable;

SBA Response: Mo. Rev. Stat. § 67.5094(1)-(2) precludes the City from requiring SBA to provide the requested information or from evaluating the requested information as part of its consideration of SBA's CUP application. However, SBA and T-Mobile conducted an analysis of potential available collocation opportunities on existing towers, structures, and buildings within the necessary and applicable coverage area but no such available towers, structures, or buildings exist. Moreover, SBA's CUP application seeks to modify and convert an existing stealth tower to a monopole design, so this criteria does not apply.

(E) Whether or not there are other limiting conditions that render existing towers, structures or buildings within the applicant's required geographic area unsuitable;

SBA Response: Mo. Rev. Stat. § 67.5094(1)-(2) precludes the City from requiring SBA to provide the requested information or from evaluating the requested

information as part of its consideration of SBA's CUP application. However, SBA and T-Mobile conducted an analysis of potential available collocation opportunities on existing towers, structures, and buildings within the necessary and applicable coverage area but no such available towers, structures, or buildings exist. Moreover, SBA's CUP application seeks to modify and convert an existing stealth tower to a monopole design, so this criteria does not apply.

(F) Whether or not the proposal minimizes the number and size of towers or structures that will be required in the area;

SBA Response: The proposal minimizes the number and size of towers required in the area by utilizing an existing site with an existing tower and simply converting that existing tower from a stealth to monopole design. Rather than constructing a new tower, the applicant is converting an existing tower to make it more usable and to provide additional and improved service and coverage to the community in the area, thereby reducing visual clutter and land use impact.

(G) Whether or not the applicant has previously failed to take advantage of available shared use opportunities provided by this section or otherwise; and

SBA Response: Mo. Rev. Stat. § 67.5094(1)-(2) precludes the City from requiring SBA to provide the requested information or from evaluating the requested information as part of its consideration of SBA's CUP application. However, SBA and T-Mobile conducted an analysis of potential available collocation opportunities on existing towers, structures, and buildings within the necessary and applicable coverage area but no such available towers, structures, or buildings exist. Moreover, SBA's CUP application seeks to modify and convert an existing stealth tower to a monopole design, so this criteria does not apply. Regardless, SBA has not previously failed to take advantage of shared use opportunities. The existing stealth tower was previously approved in 2012 as a stealth monopole design, which limits carrier ability to upgrade equipment. The proposed change to standard monopole will be engineered to support co-location and newer 5G technology.

(H) Whether or not the applicant has provided sufficient evidence indicating that the tower will be made available for use by others, subject to reasonable technical limitations and reasonable financial terms.

SBA Response: The proposed monopole will be made available for shared use by other carriers, subject to reasonable technical limitations and financial terms. On the existing stealth tower, T-Mobile is mounted at 85 feet and AT&T is mounted at 106 feet, and there is availability for additional equipment to be mounted at 75 feet and also 96 feet. These mounting heights and collocation abilities will not change with the requested modification. The design will include capacity for multiple antenna arrays, promoting infrastructure efficiency and reducing the need for additional towers.

ANCHOR





By rhooker at 9:38:15 AM, 7/14/2025

SITE NUMBER: MO08134B

SITE NAME: SBA BROADWAY COLUMBIA **SBA SITE NUMBER:** MO17428-A-02 **SBA SITE NAME:**

WEST BROADWAY

JURISDICTION: **CITY OF COLUMBIA** SITE TYPE: STEALTH MONOPOLE

SITE ADDRESS: 1201 WEST BROADWAY COLUMBIA, MO 65203 **BOONE COUNTY**

TITLE SHEET

GENERAL NOTES

SITE DETAILS

OVERALL SITE PLAN

TOWER ELEVATION

EQUIPMENT DETAILS

EQUIPMENT DETAILS

EQUIPMENT DETAILS

EQUIPMENT DETAILS

EQUIPMENT DETAILS

FOUIPMENT DETAILS

EQUIPMENT DETAILS

EQUIPMENT DETAILS

ELECTRICAL DETAILS

GROUNDING DETAILS

TOWER MODIFICATION DRAWINGS

GROUNDING RISER

UTILITY PLAN

ANTENNA PLANS

EXISTING & NEW SITE PLANS

ANTENNA & CABLE SCHEDULE

LOCATION MAP SITE LOCATION er CPA 0 MAP DATA © 2024 GOOGLE

AERIAL MAP

PROJECT DESCRIPTION

NO NEW WATER OR SEWER IS REQUIRED AS FACILITY IS UNMANNED.

EXISTING T-MOBILE BUILD OUT:

(3) ANTENNAS, (6) TMA'S, (12) COAX, (4) RF MODULES, (1) UNKNOWN MODULE, (2) SYSTEM MODULES, (1) CHAIR MOUNT & (1) SSC AT GRADE

FINAL T-MOBILE BUILD OUT:

(6) ANTENNAS, (6) RRU'S, (2) HCS 6x24 TRUNKS, (8) COAX, (1) SITE SUPPORT CABINET, (1) BBU CABINET, & (2) AMIA'S IN SSC

SCOPE OF WORK:

- EXISTING CONCEALMENT CANISTER TO BE REMOVED & NEW TOWER SECTION TO BE INSTALLED.
- NEW ANTENNA PLATFORM TO BE INSTALLED
- REMOVE (3) EXISTING ANTENNAS
- REMOVE (6) EXISTING TMA'S AT ANTENNAS
- REMOVE (4) EXISTING COAX
- REMOVE (1) EXISTING UNKNOWN MODULE REMOVE (2) EXISTING LTE-AWS FRIE'S
- REMOVE (2) EXISTING UMTS/LTE-PCS FXFC'S
- REMOVE (1) EXISTING UMTS-PCS FSMF
- REMOVE (1) EXISTING LTE/AWS/PCS FSMF
- REMOVE (1) EXISTING FBBC SUBMODULE REMOVE (1) EXISTING SITE SUPPORT CABINET
- REMOVE (1) EXISTING CHAIR MOUNT
- INSTALL (2) NEW ICE BRIDGE SECTIONS REMOVE EXISTING FSEB
- INSTALL NEW FSEE
- REMOVE EXISTING PPC
- INSTALL NEW 225A PPC
- INSTALL (3) NEW ANTENNAS (1 PER SECTOR)
- INSTALL (3) NEW ANTENNAS W/ INTEGRATED RRU'S (1 PER SECTOR)
- INSTALL (3) NEW AHFII'S (1 PER SECTOR) INSTALL (3) NEW AHLOB'S (1 PER SECTOR)
- INSTALL (2) NEW HCS 6x24 TRUNKS
- INSTALL (1) NEW SITE SUPPORT CABINET
- INSTALL (1) NEW BBU CABINET INSTALL (1) NEW AMIA WITH (1) ASIA CORE MODULE AND (2) ABIA
- CAPACITY MODULES INSTALL (1) NEW AMIA WITH (2) ASIL CORE MODULES, (1) ABIO
- CAPACITY MODULE AND (3) ABIL CAPACITY MODULES REMOVE EXISTING CSR 7705 SAR A

PROJECT TEAM

A&E:

WT GROUP, LLC. 2675 PRATUM AVENUE HOFFMAN ESTATES, IL 60192 CONTACT: TIM KUEN TEL: (224) 293-6333 FAX: (224) 293-6444

APPLICANT:

T-MOBILE 6200 SPRINT PKWY OVERLAND PARK, KS 66211 TEL: (855) 977-5086

STRUCTURAL:

TOWER ENGINEERING SOLUTIONS 1320 GREENWAY DRIVE, SUITE 600 IRVING, TX 75038 FAX: (972) 975-9615

SBA COMMUNICATION TEL: (800) 487-SITE (7483)

1201 WEST BROADWAY

TOWER INFORMATION

STRUCTURE HEIGHT: 110'-0" STEALTH MONOPOLE - HIGHEST TOWER APPURTENANCE: T.B.D. - T-MOBILE ANTENNA RAD CENTER: 85'-0"/87'-6"

COORDINATES (NAD 1983)

LATITUDE: 38.953200° N

GROUND ELEVATION

725.00' (PER GOOGLE EARTH)

SHEET INDEX DESCRIPTION SHEET NUMBER: SITE ACQUISITION:

C-1

C-2

C-3

A-1

A-2

A-3

A-4

A-5

A-6

A-7

A-8

A-10

A-11

E-1

F-2

GR-1

GR-2

SBA COMMUNICATION CORPORATION 8051 CONGRESS AVENUE BOCA RATON, FL 33487-1307 TEL: (800) 487-SITE (7483)

TOWER OWNER:

8051 CONGRESS AVENUE BOCA RATON, FL 33487-1307

PROPERTY INFORMATION

SITE ADDRESS

COLUMBIA, MO 65203

T-MOBILE ANTENNA TIP HEIGHT: 89'-0"/89'-0"

-92.357117° W

UTILITIES

ELECTRIC:

CONTACT: N/A TEL: N/A

FIBER:

CONTACT: N/A



(now what's below.

CODE COMPLIANCE

ALL WORK AND MATERIALS SHALL BE PERFORMED AND INSTALLED IN ACCORDANCE WITH THE FOLLOWING CODES AS ADOPTED BY THE LOCAL GOVERNING AUTHORITIES. NOTHING IN THESE PLANS IS TO BE CONSTRUED TO PERMIT WORK NOT CONFORMING TO THE FOLLOWING CODES:

BUILDING CODE:

2018 INTERNATIONAL BUILDING CODE

ELECTRICAL CODE:

2017 NATIONAL ELECTRICAL CODE (2017 NEC)

REFERENCED MATERIALS

A SITE WALK WAS NOT PERFORMED FOR THIS SITE PER SCOPE OF WORK. COMPOUND, ELEVATION, EQUIPMENT LAYOUT AND ANTENNA PLANS SHOWN WITHIN THIS SET WERE TAKEN FROM AVAILABLE DOCUMENTS/DRAWINGS PROVIDED BY OTHERS.

Mobile

WT GROUP

SBA BROADWAY COLUMBIA



REV.	ISSUED FOR	DATE	
Α	FOR CLIENT REVIEW	12/18/24	F
0	FINAL	01/08/25	1
1	REVISION	01/15/25	1
2	REVISION	06/23/25	1
3	REVISION	07/08/25	I
		•	

T-1

CHECK: JKR

DRAWN: RAK

JOB: T2400870

TITLE SHEET

GENERAL REQUIREMENTS:

1.1 INTENT

- THESE SPECIFICATIONS AND CONSTRUCTION DRAWINGS ACCOMPANYING THEM DESCRIBE THE WORK TO BE DONE AND THE MATERIALS TO BE FURNISHED FOR CONSTRUCTION.
- THE DRAWINGS AND SPECIFICATIONS ARE INTENDED TO BE FULLY EXPLANATORY AND SUPPLEMENTARY. HOWEVER, SHOULD ANYTHING BE SHOWN, INDICATED OR SPECIFIED ON ONE AND NOT THE OTHER, IT SHALL BE DONE THE SAME AS IF SHOWN, INDICATED OR SPECIFIED IN BOTH.
- THE INTENTION OF THE DOCUMENTS IS TO INCLUDE ALL LABOR AND MATERIALS REASONABLY NECESSARY FOR THE PROPER EXECUTION AND COMPLETION OF THE WORK AS STIPULATED IN THE CONTRACT.
- THE PURPOSE OF THE SPECIFICATIONS IS TO INTERPRET THE INTENT OF THE DRAWINGS AND TO DESIGNATE THE METHOD OF THE PROCEDURE TYPE AND QUALITY OF MATERIALS REQUIRED TO COMPLETE THE WORK
- MINOR DEVIATIONS FROM THE DESIGN LAYOUT ARE ANTICIPATED AND SHALL BE CONSIDERED AS PART OF THE WORK. NO CHANGES THAT ALTER THE CHARACTER OF THE WORK WILL BE MADE OR PERMITTED BY THE OWNER WITHOUT ISSUING A CHANGE ORDER.

1.2 CONFLICTS

- THE CONTRACTOR SHALL BE RESPONSIBLE FOR VERIFICATION OF ALL MEASUREMENTS AT THE SITE BEFORE ORDERING ANY MATERIALS OR DOING ANY WORK. NO EXTRA CHARGE OR COMPENSATION SHALL BE ALLOWED DUE TO DIFFERENCE BETWEEN ACTUAL DIMENSIONS AND DIMENSIONS INDICATED ON THE CONSTRUCTION DRAWINGS. ANY SUCH DISCREPANCY IN DIMENSION WHICH MAY BE FOUND SHALL BE SUBMITTED TO THE OWNER FOR CONSIDERATION BEFORE THE CONTRACTOR PROCEEDS WITH THE WORK IN THE AFFECTED AREAS.
- THE BIDDER, IF AWARDED THE CONTRACT, WILL NOT BE ALLOWED ANY EXTRA COMPENSATION BY REASON OF ANY MATTER OR THING CONCERNING WHICH SUCH BIDDER MIGHT HAVE FULLY INFORMED THEMSELVES PRIOR TO
- NO PLEA OF IGNORANCE OF CONDITIONS THAT EXIST, OR OF DIFFICULTIES OR CONDITIONS THAT MAY BE ENCOUNTERED OR OF ANY OTHER RELEVANT MATTER CONCERNING THE WORK TO BE PERFORMED IN THE EXECUTION OF THE WORK WILL BE ACCEPTED AS AN EXCUSE FOR ANY FAILURE OR OMISSION ON THE PART OF THE CONTRACTOR TO FULFILL EVERY DETAIL OF ALL THE REQUIREMENTS OF THE CONTRACT DOCUMENTS GOVERNING THE

1.3 CONTRACTS AND WARRANTIES

CONTRACTOR IS RESPONSIBLE FOR APPLICATION AND PAYMENT OF CONTRACTOR LICENSES AND BONDS.

- ALL MATERIALS MUST BE STORED IN A LEVEL AND DRY FASHION AND IN A MANNER THAT DOES NOT NECESSARILY OBSTRUCT THE FLOW OF OTHER WORK. ANY STORAGE METHOD MUST MEET ALL RECOMMENDATIONS OF THE ASSOCIATED MANUFACTURER
- 2. THE BTS MUST BE STORED INSIDE UNTIL THERE IS POWER ON SITE.

- THE CONTRACTORS SHALL AT ALL TIMES KEEP THE SITE FREE FROM ACCUMULATION OF WASTE MATERIALS OR RUBBISH CAUSED BY THEIR EMPLOYEES AT WORK AND AT THE COMPLETION OF THE WORK, THEY SHALL REMOVE ALL RUBBISH FROM AND ABOUT THE BUILDING AREA INCLUDING ALL THEIR TOOLS, SCAFFOLDING AND SURPLUS MATERIALS AND SHALL LEAVE THEIR WORK CLEAN AND READY FOR USE
- EXTERIOR: VISUALLY INSPECT EXTERIOR SURFACES AND REMOVE ALL TRACES OF SOIL, WASTE MATERIALS, SMUDGES AND OTHER FOREIGN
 - REMOVE ALL TRACES OF SPLASHED MATERIALS FROM ADJACENT
 - IF NECESSARY TO ACHIEVE A UNIFORM DEGREE OF CLEANLINESS, HOSE DOWN THE EXTERIOR OF THE STRUCTURE
- INTERIOR: VISUALLY INSPECT INTERIOR SURFACE AND REMOVE ALL TRACES OF SOIL, WASTE MATERIALS, SMUDGES AND OTHER FOREIGN MATTER FROM WALLS/FLOOR/CELLING
 - REMOVE ALL TRACES OF SPLASHED MATERIAL FROM ADJACENT
 - REMOVE PAINT DROPPINGS, SPOTS, STAINS AND DIRT FROM FINISHED SURFACES

CHANGE ORDERS MAY BE INITIATED BY THE OWNER AND/OR THE CONTRACTOR INVOLVED. THE CONTRACTOR, UPON VERBAL REQUEST FROM THE OWNER SHALL PREPARE A WRITTEN PROPOSAL DESCRIBING THE CHANGE IN WORK OR MATERIALS AND ANY CHANGES IN THE CONTRACT AMOUNT AND PRESENT TO THE OWNER WITHIN 72 HRS FOR APPROVAL SUBMIT REQUESTS FOR SUBSTITUTIONS IN THE FORM AND IN ACCORDANCE WITH PROCEDURES REQUIRED FOR CHANGE ORDER PROPOSALS. ANY CHANGES IN SCOPE OF WORK OR MATERIALS WHICH ARE PERFORMED BY THE CONTRACTOR WITHOUT A WRITTEN CHANGE ORDER AS DESCRIBED AND APPROVED BY THE OWNER SHALL PLACE FULL RESPONSIBILITY OF THESE ACTIONS ON THE CONTRACTOR

1.7 RELATED DOCUMENTS AND COORDINATION

1. GENERAL CARPENTRY, ELECTRICAL AND ANTENNA DRAWINGS ARE. INTERRELATED. IN PERFORMANCE OF THE WORK, THE CONTRACTOR MUST REFER TO ALL DRAWINGS. ALL COORDINATION TO BE THE RESPONSIBILITY OF THE CONTRACTOR.

1.8 SHOP DRAWING

- CONTRACTOR SHALL SUBMIT SHOP DRAWINGS AS REQUIRED AND LISTED IN THESE SPECIFICATIONS TO THE OWNER FOR APPROVAL
- ALL SHOP DRAWINGS SHALL BE REVIEWED, CHECKED AND CORRECTED BY

- 1.9 PRODUCTS AND SUBSTITUTIONS
 1. SUBMIT 3 COPIES OF EACH REQUEST FOR SUBSTITUTION. IN EACH REQUEST IDENTIFY THE PRODUCT OR FABRICATION OR INSTALLATION METHOD TO BE REPLACED BY THE SUBSTITUTION. INCLUDE RELATED SPECIFICATION SECTION AND DRAWING NUMBERS AND COMPLETE DOCUMENTATION SHOWING COMPLIANCE WITH THE REQUIREMENTS FOR SUBSTITUTIONS
- SUBMIT ALL NECESSARY PRODUCT DATA AND CUT SHEETS WHICH PROPERLY INDICATE AND DESCRIBE THE ITEMS, PRODUCTS AND MATERIALS BEING INSTALLED. THE CONTRACTOR SHALL, IF DEEMED NECESSARY BY THE OWNER SUBMIT ACTUAL SAMPLES TO THE OWNER FOR APPROVAL IN LIEU OF CUT SHEETS.

1.10 QUALITY ASSURANCE

ALL WORK SHALL BE IN ACCORDANCE WITH APPLICABLE LOCAL, STATE AND FEDERAL REGULATIONS.

- BEFORE THE COMMENCEMENT OF ANY WORK, THE CONTRACTOR WILL ASSIGN A PROJECT MANAGER WHO WILL ACT AS A SINGLE POINT OF CONTACT FOR ALL PERSONNEL INVOLVED IN THIS PROJECT. THIS PROJECT MANAGER WILL DEVELOP A MASTER SCHEDULE FOR THE PROJECT WHICH WILL BE SUBMITTED TO THE OWNER PRIOR TO THE COMMENCEMENT OF
- SUBMIT A BAR TYPE PROGRESS CHART NOT MORE THAN 3 DAYS AFTER THE DATE ESTABLISHED FOR COMMENCEMENT OF THE WORK ON THE SCHEDULE, INDICATING A TIME BAR FOR EACH MAJOR CATEGORY OR UNIT OF WORK TO BE PERFORMED AT SITE, PROPERLY SEQUENCED AND COORDINATED WITH OTHER ELEMENTS OF WORK AND SHOWING COMPLETION OF THE WORK SUFFICIENTLY IN ADVANCE OF THE DATE ESTABLISHED FOR SUBSTANTIAL COMPLETION OF THE WORK
- PRIOR TO COMMENCING CONSTRUCTION, THE OWNER SHALL SCHEDULE AN ON-SITE MEETING WITH ALL MAJOR PARTIES. THIS WOULD INCLUDE (THOUGH NOT LIMITED TO) THE OWNER, PROJECT MANAGER, CONTRACTOR, LAND OWNER REPRESENTATIVE, LOCAL TELEPHONE COMPANY, TOWER ERECTION FOREMAN (IF SUBCONTRACTED).
- CONTRACTOR SHALL BE EQUIPPED WITH SOME MEANS OF CONSTANT COMMUNICATIONS, SUCH AS A MOBILE PHONE OR A BEEPER. THIS EQUIPMENT WILL NOT BE SUPPLIED BY THE OWNER, NOR WILL WIRELESS SERVICE BE ARRANGED
- DURING CONSTRUCTION, CONTRACTOR MUST ENSURE THAT EMPLOYEES AND SUBCONTRACTORS WEAR HARD HATS AT ALL TIMES. CONTRACTOR WILL COMPLY WITH ALL SAFETY REQUIREMENTS IN THEIR AGREEMENT
- PROVIDE WRITTEN DAILY UPDATES ON SITE PROGRESS TO THE OWNER.
- COMPLETE INVENTORY OF CONSTRUCTION MATERIALS AND EQUIPMENT IS REQUIRED PRIOR TO START OF CONSTRUCTION.
- NOTIFY THE OWNER / PROJECT MANAGER IN WRITING NO LESS THAN 48 HOURS IN ADVANCE OF CONCRETE POURS, TOWER ERECTIONS, AND EQUIPMENT CABINET PLACEMENTS.

1.12 INSURANCE AND BONDS

- CONTRACTOR SHALL AT THEIR OWN EXPENSE CARRY AND MAINTAIN FOR THE DURATION OF THE PROJECT ALL INSURANCE AS REQUIRED AND LISTED AND SHALL NOT COMMENCE WITH THEIR WORK UNTIL THEY HAVE PRESENTED AN ORIGINAL CERTIFICATE OF INSURANCE STATING ALL COVERAGES TO THE OWNER REFER TO THE MASTER AGREEMENT FOR
- THE OWNER SHALL BE NAMED AS AN ADDITIONAL INSURED ON ALL POLICIES.
- CONTRACTOR MUST PROVIDE PROOF OF INSURANCE

ANTENNA INSTALLATION:

- 1.1 REQUIREMENTS OF REGULATOR AGENCIES
 1. FURNISH U.L. LISTED EQUIPMENT WHERE SUCH LABEL IS AVAILABLE, INSTALL IN CONFORMANCE WITH U.L. STANDARDS WHERE APPLICABLE
- INSTALL ANTENNA, ANTENNA CABLES, GROUNDING SYSTEM IN ACCORDANCE WITH DRAWINGS AND SPECIFICATION IN EFFECT AT PROJECT LOCATION AND RECOMMENDATIONS OF STATE AND LOCAL BUILDING CODES SPECIAL CODES HAVING JURISDICTION OVER SPECIFIC PORTIONS OF WORK THIS INCLUDES BUT IS NOT LIMITED TO THE FOLLOWING:
- TIA TELECOMMUNICATIONS INDUSTRY ASSOCIATION TIA-222-H. STRUCTURAL STANDARDS FOR STEEL ANTENNA TOWERS AND ANTENNA SUPPORTING STRUCTURES
- FAA FEDERAL AVIATION ADMINISTRATION ADVISORY CIRCULAR AC 70/7460-IH. OBSTRUCTION MARKING AND LIGHTING
- FCC FEDERAL COMMUNICATIONS COMMISSION RULES AND REGULATIONS FORM 715. OBSTRUCTION MARKING AND LIGHTING SPECIFICATIONS FOR ANTENNA STRUCTURES AND FORM 715A, HIGH INTENSITY OBSTRUCTION LIGHTING SPECIFICATIONS FOR ANTENNA
- AISC AMERICAN INSTITUTE OF STEEL CONSTRUCTION SPECIFICATION FOR STRUCTURAL JOINTS USING ASTM A325 OR A490 BOLTS.
- NEC NATIONAL ELECTRICAL CODE ON TOWER LIGHTING KITS.
- UL LINDERWRITER'S LABORATORIES APPROVED ELECTRICAL
- IN ALL CASES, PART 77 OR THE FAA RULES AND PARTS 17 AND 22 OF THE FCC RULES ARE APPLICABLE AND IN THE EVENT OF CONFLICT, SUPERSEDE ANY OTHER STANDARDS OR SPECIFICATIONS.
- 2012 LIFE SAFETY CODE NFPA -101.

GENERAL ELECTRIC PROVISION:

- SUBMITTAL OF BID INDICATES CONTRACTOR IS COGNIZANT OF ALL JOB SITE CONDITIONS AND WORK TO BE PERFORMED UNDER THIS CONTRACT.
- CONTRACTOR SHALL PERFORM ALL VERIFICATION OBSERVATIONS TEST AND EXAMINATION WORK PRIOR TO THE ORDERING OF THE ELECTRICAL EQUIPMENT AND THE ACTUAL CONSTRUCTION. CONTRACTOR SHALL ISSUE A WRITTEN NOTICE OF ALL FINDINGS TO THE ARCHITECT LISTING ALL MALFUNCTIONS, FAULTY EQUIPMENT AND DISCREPANCIES
- EACH CONDUCTOR OF EVERY SYSTEM SHALL BE PERMANENTLY TAGGED IN EACH PANEL BOARD, PULL BOX, J-BOX, SWITCH BOX, ETC., IN COMPLIANCE WITH OCCUPATIONAL SAFETY AND HEALTH ACT (O.S.H.A.).
- CONTRACTOR SHALL PROVIDE ALL LABOR, MATERIALS, INSURANCE, EQUIPMENT, INSTALLATION, CONSTRUCTION TOOLS, TRANSPORTATION, ETC. FOR A COMPLETE AND PROPERLY OPERATIVE SYSTEM ENERGIZED. THROUGHOUT AND AS INDICATED ON DRAWINGS, AS SPECIFIED HEREIN AND/OR AS OTHERWISE REQUIRED
- ALL MATERIALS AND EQUIPMENT SHALL BE NEW AND IN PERFECT CONDITION WHEN INSTALLED AND SHALL BE OF THE BEST GRADE AND OF THE SAME MANUFACTURER THROUGHOUT FOR EACH CLASS OR GROUP OF FOUIPMENT MATERIALS SHALL BE LISTED "J" WHERE SUBJECT TO SUCH APPROVAL. MATERIALS SHALL MEET WITH APPROVAL OF THE DIVISION OF INDUSTRIAL SAFETY AND ALL GOVERNING BODIES HAVING JURISDICTION. MATERIALS SHALL BE MANUFACTURED IN ACCORDANCE WITH APPLICABLE STANDARDS ESTABLISHED BY ANSI, NEMA AND NBFU.
- ALL CONDUIT INSTALLED SHALL BE SURFACE MOUNTED OR DIRECT BURIAL 6.
- CONTRACTOR SHALL CARRY OUT THEIR WORK IN ACCORDANCE WITH ALL GOVERNING STATE COUNTY AND LOCAL CODES AND O.S.H.A.
- CONTRACTOR TO OBTAIN ALL PERMITS, PAY PERMIT FEES, AND BE RESPONSIBLE FOR SCHEDULING INSPECTIONS.
- COMPLETE JOB SHALL BE GUARANTEED FOR A PERIOD OF ONE (1) YEAR AFTER THE DATE OF JOB ACCEPTANCE BY OWNER, ANY WORK, MATERIAL OR EQUIPMENT FOUND TO BE FAULTY DURING THAT PERIOD SHALL BE CORRECTED AT ONCE, UPON WRITTEN NOTIFICATION, AT THE EXPENSE OF THE CONTRACTOR
- 10. ALL CONDUIT SHALL HAVE A PULL WIRE OR ROPE

- PROVIDE PROJECT MANAGER WITH ONE SET OF COMPLETE ELECTRICAL "AS INSTALLED" DRAWINGS AT THE COMPLETION OF THE JOB, SHOWING ACTUAL DIMENSIONS, ROUTINGS AND CIRCUITS
- ALL BROCHURES, OPERATING MANUALS, CATALOGS, SHOP DRAWINGS, ETC., SHALL BE TURNED OVER TO THE OWNER AT JOB COMPLETION.
- USE T-TAP CONNECTIONS ON ALL MULTI-CIRCUITS WITH COMMON NEUTRAL CONDUCTOR FOR LIGHTING FIXTURES.
- ALL CONDUCTORS SHALL BE COPPER.
- ALL CIRCUIT BREAKERS, FUSES AND ELECTRICAL EQUIPMENT SHALL HAVE AN INTERRUPTING SHORT CIRCUIT CURRENT TO WHICH THEY MAY BE SUBJECTED, AND A MINIMUM OF 10,000 A.I.C.
- THE ENTIRE ELECTRICAL INSTALLATION SHALL BE GROUNDED AS REQUIRED BY ALL APPLICABLE CODES.
- PATCH, REPAIR AND PAINT ANY AREA THAT HAS BEEN DAMAGED IN THE COURSE OF THE ELECTRICAL WORK
- PENETRATIONS IN FIRE RATED WALLS SHALL BE FIRE STOPPED IN ACCORDANCE WITH APPLICABLE LOCAL BUILDING CODES.
- WIRE AND CABLE CONDUCTORS SHALL BE COPPER #12 AWG MINIMUM UNLESS SPECIFICALLY NOTED OTHERWISE ON DRAWINGS.
- GROUNDING CONDUCTORS SHALL BE SOLID TINNED COPPER UNLESS OTHERWISE NOTED.
- 21. ALL MATERIALS SHALL BE U.L. LISTED.
- 22. CONDUIT
 - RIGID CONDUIT SHALL BE U.L. LABEL GALVANIZED ZINC COATED WITH ZINC INTERIOR AND SHALL BE USED WHEN INSTALLED IN OR UNDER CONCRETE SLABS IN CONTACT WITH THE EARTH, UNDER PUBLIC ROADWAYS, IN MASONRY WALLS OR EXPOSED ON BUILDING EXTERIOR. RIGID CONDUIT IN CONTACT WITH EARTH SHALL BE 1/2 LAPPED WRAPPED WITH HUNTS WRAP PROCESS NO. 3
 - ELECTRICAL METALLIC TUBING SHALL HAVE U.L. LABEL, FITTING SHALL BE GLAND RING COMPRESSION TYPE, EMT SHALL BE USED ONLY FOR
 - ELEXIBLE METALLIC CONDUIT SHALL HAVE ULL LISTED LABEL AND MAY BE USED WHERE PERMITTED BY CODE. FITTINGS SHALL BE "JAKE" OR "SQUEEZE" TYPE, SEAL TIGHT FLEXIBLE CONDUIT. ALL CONDUIT SHALL HAVE FULL SIZE FOUIPMENT GROUND WIRE
 - CONDUIT RUNS SHALL BE SURFACE MOUNTED UNLESS INDICATED OTHERWISE, CONDUIT INDICATED SHALL RUN PARALLEL OR AT RIGHT ANGLES TO CEILING, FLOOR OR BEAMS. VERIFY EXACT ROUTING OF ALL EXPOSED CONDUIT WITH THE OWNER PRIOR TO INSTALLING. NO HORIZONTAL CONDUITS SHALL BE BELOW 7'-6" A.F.F. NO BX OR ROMEX CABLE IS PERMITTED.
 - PARALLEL UNDERGROUND CONDUIT SHALL BE PVC SCHEDULE 40 (UNLESS NOTED OTHERWISE) AT A MINIMUM DEPTH OF 30" BELOW GRADE - STACKED UNDERGROUND CONDUIT SHALL BE PVC SCHEDULE 40 (UNLESS NOTED OTHERWISE) AT A MINIMUM DEPTH OF 24" BELOW
 - ABOVE GROUND CONDUIT SHALL BE P.V.C. SCHEDULE 80 (UNLESS NOTED OTHERWISE)
- ALL ELECTRICAL EQUIPMENT SHALL BE LABELED WITH PERMANENT ENGRAVED PLASTIC LABELS.
- UPON COMPLETION OF WORK, CONDUCT CONTINUITY, SHORT CIRCUIT, AND FALL OF POTENTIAL GROUND TESTS FOR APPROVAL SUBMIT TEST REPORTS TO PROJECT MANAGER. CLEAN PREMISES OF ALL DEBRIS RESULTING FROM WORK AND LEAVE WORK IN A COMPLETE AND UNDAMAGED CONDITION.

m

WT GROUP
Engineering with Precision, Pace an

STST Fratum Awarue Hoffman Esta

T: 224,298,6338 | F: 224,298,6444
www.groom Mobile

SBA BROADWAY COLUMBIA
MO08134B
1201 WEST BROADWAY
COLUMBIA, MO 65203



SIGNED: 07/08/2 REVISIONS DATE E REV. ISSUED FOR A FOR CLIENT REVIEW 12/18/24 RAM 0 FINAL 01/08/25 TRI 1 REVISION 01/15/25 TRI 2 REVISION 06/23/25 TRI 3 REVISION 07/08/25 TRI

> DRAWN: RAK JOB: T2400870

GENERAL NOTES

GN-1

CHECK: JKR

GENERAL SITE NOTES:

- CONTRACTOR WILL NOT START CONSTRUCTION UNTIL AFTER THEY HAVE RECEIVED THE PRE-CON PACKAGE AND HAVE A PRE-CON WALK WITH THE
- CONTRACTOR TO HIRE PUBLIC (811) AND PRIVATE LOCATING SERVICE IN ORDER TO LOCATE AND PROTECT ALL SURFACE UTILITIES. DO NOT SCALE OFF THESE PLANS FOR ANY BELOW GRADE
- CONTRACTOR SHALL VERIFY ALL EXISTING BURIED AND OVERHEAD UTILITIES PRIOR TO EXCAVATION. CONTRACTOR SHALL REPAIR ALL DAMAGED UTILITIES AT HIS OWN COST AND UTILITY COMPANY.
- CONTRACTOR TO VERIFY ALL HEIGHTS AND AZIMUTHS IN FIELD PRIOR TO CONSTRUCTION. CONTRACTOR SHALL NOTIFY T-MOBILE AND ENGINEERING FIRM OF ANY DISCREPANCIES BEFORE PROCEEDING.
- CONTRACTOR SHALL RESTORE AND REPAIR ANY DAMAGED AREAS CAUSED BY CONSTRUCTION.



OVERALL SITE PLAN

SCALE: 1" = 60'-0"

1

REVISIONS

REV. ISSUED FOR A FOR CLIENT REVIEW

0 FINAL

1 REVISION

2 REVISION

. CHECK: JKR DRAWN: RAK JOB: T2400870 **C-1**

S. GUTOWSKY

WT GROUP

Engineering with Precision, Pace an
Zer's Pentum Avenue Hoffman Esta
7: 224.208.6339 | F. 224.208.6444
winesplacering.com

SBA BROADWAY COLUMBIA
MO08134B
1201 WEST BROADWAY
COLUMBIA, MO 65203

Mobile


OVERALL SITE PLAN


12/18/24 RAK

01/08/25 TRF

01/15/25 TRK

06/23/25 TRK 07/08/25 TRF

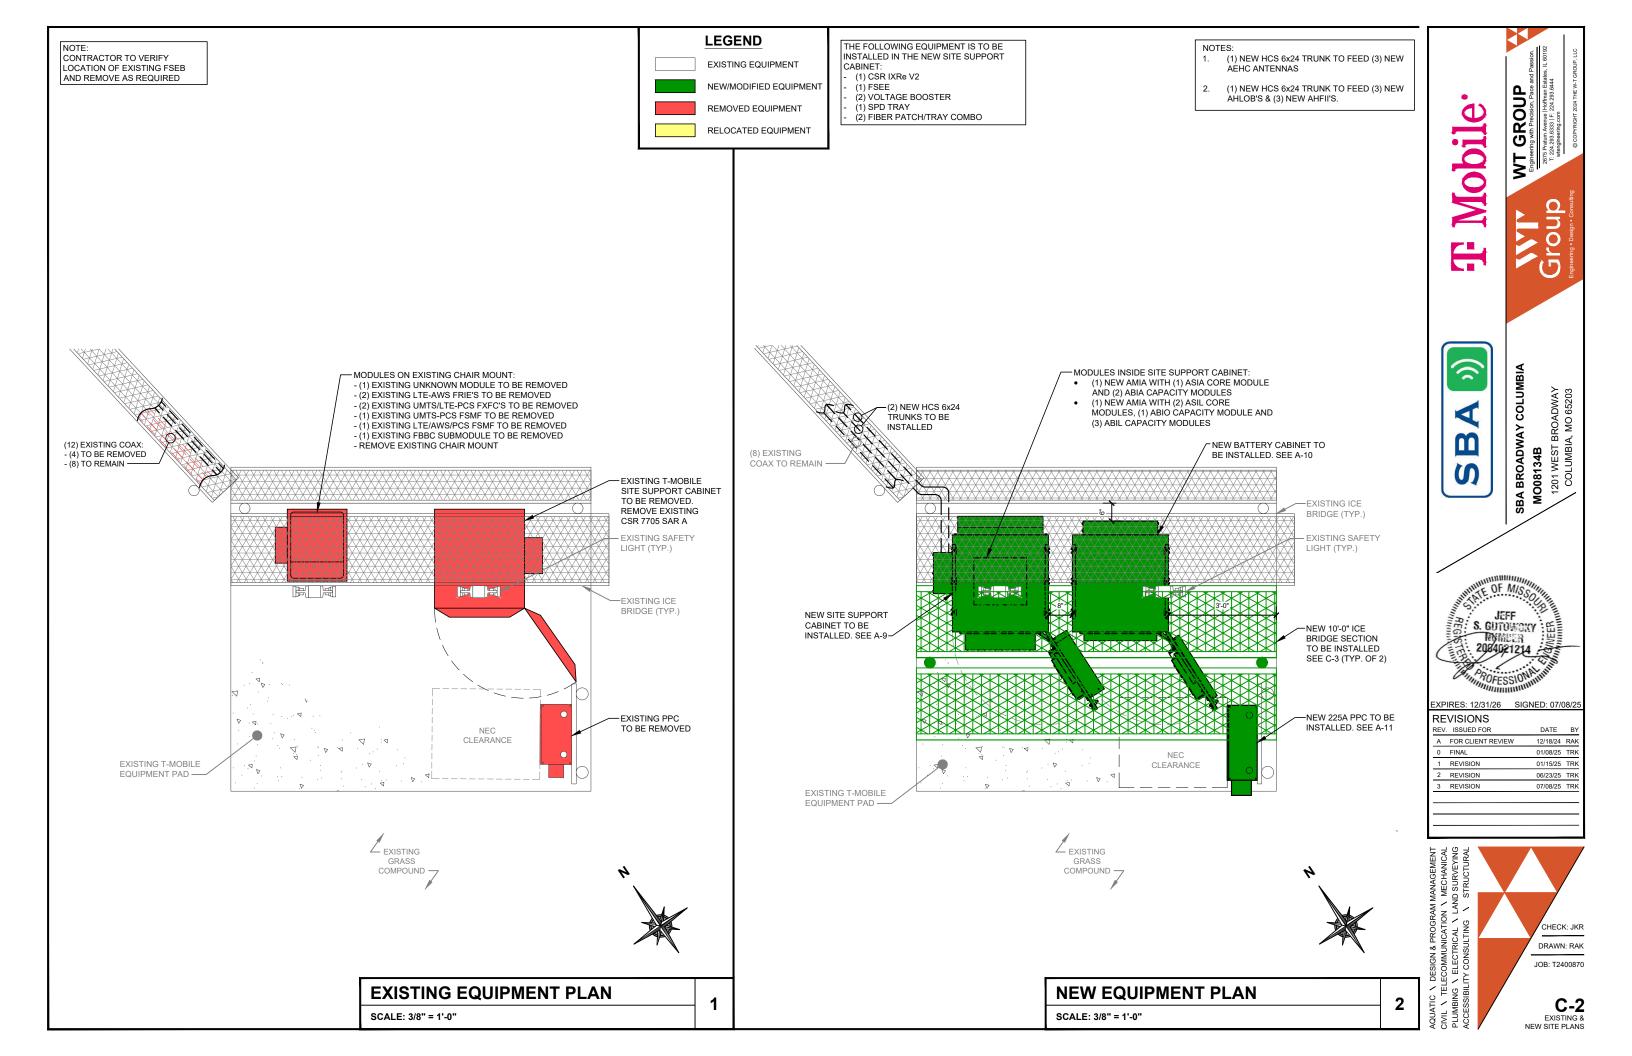

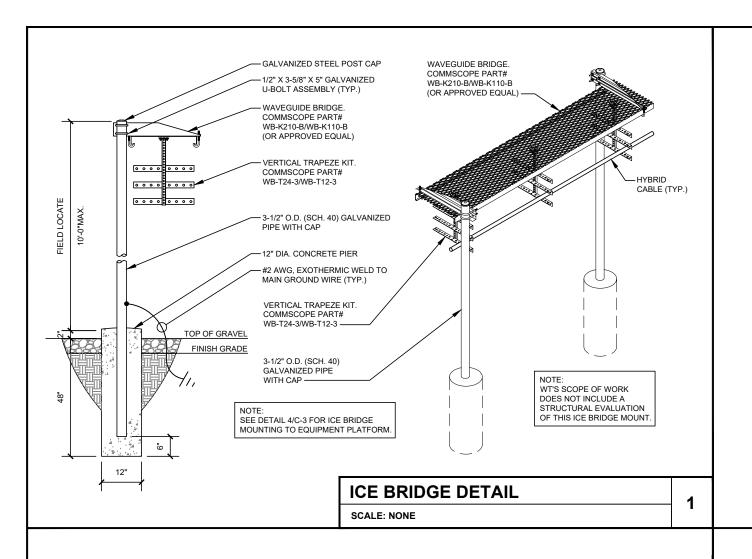

USE THIS

SECTION UNDER PAVEMENT

OR VEHICLE

TRAFFIC

AREA

SAND

NOT USED

SCALE: NONE

USE THIS SECTION UNDER GRASS OR LAWN AREA RESTORE SURFACE TO ORIGINAL CONDITION 6" WIDE UTILITY WARNING TAPE (8" TO 12" BELOW GRADE) ENTIRE LENGTH RETURN ORIGINAL MATERIAL TO TRENCH, COMPACT TO 95% STANDARD PROCTOR GRADE 9/CA-6 GRAVEL COMPACTED TO 95% STANDARD PROCTOR FOR NEW FLECTRICAL TELEPHONE OR FIBER SERVICES - SEE UTILITY AND SITE PLANS. PROVIDE APPROVED PULL BOXES AS REQUIRED AND COORDINATE
INSTALLATION WITH ALL UTILITY COMPANIES FOR INTERFACING AT 12" TERMINATION POINTS PROVIDE FULL LENGTH PULL ROPES (TYP.)

UTILITY TRENCH DETAIL

SCALE: NONE

CONTRACTOR MUST SCAN SLABS PRIOR TO CONSTRUCTION. NO CUTTING, DRILLING, OR DAMAGING REINFORCEMENT IS ALLOWED.

NEW POST

(4) 3/8" GUSSET

PL 8" x 8" x 3/8"

(4) 5/8" DIA SS HII TI

KWIKBOLT III EXPANSION

ANCHOR WITH 4" MINIMUM

BASE PLATE DETAIL

(4) 3/8" GUSSET

(4) 5/8" DIA. SS HILTI

MINIMUM EMBEDMENT

KWIKBOLT III EXPANSION ANCHOR WITH 4"

3/16"


SCALE: NONE

- NEW 3" DIA. POST

- PL 8" x 8" x 3/8"



SBA BROADWAY COLUMBIA MO08134B

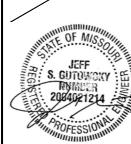


2

REVISIONS REV. ISSUED FOR 12/18/24 RAH A FOR CLIENT REVIEW 0 FINAL 01/08/25 TRF 1 REVISION 01/15/25 TRK 2 REVISION 06/23/25 TRH 07/08/25 TRF




JOB: T2400870 **C-3**

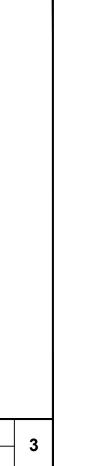


TYP. EA.

3/16"

CONCRETE

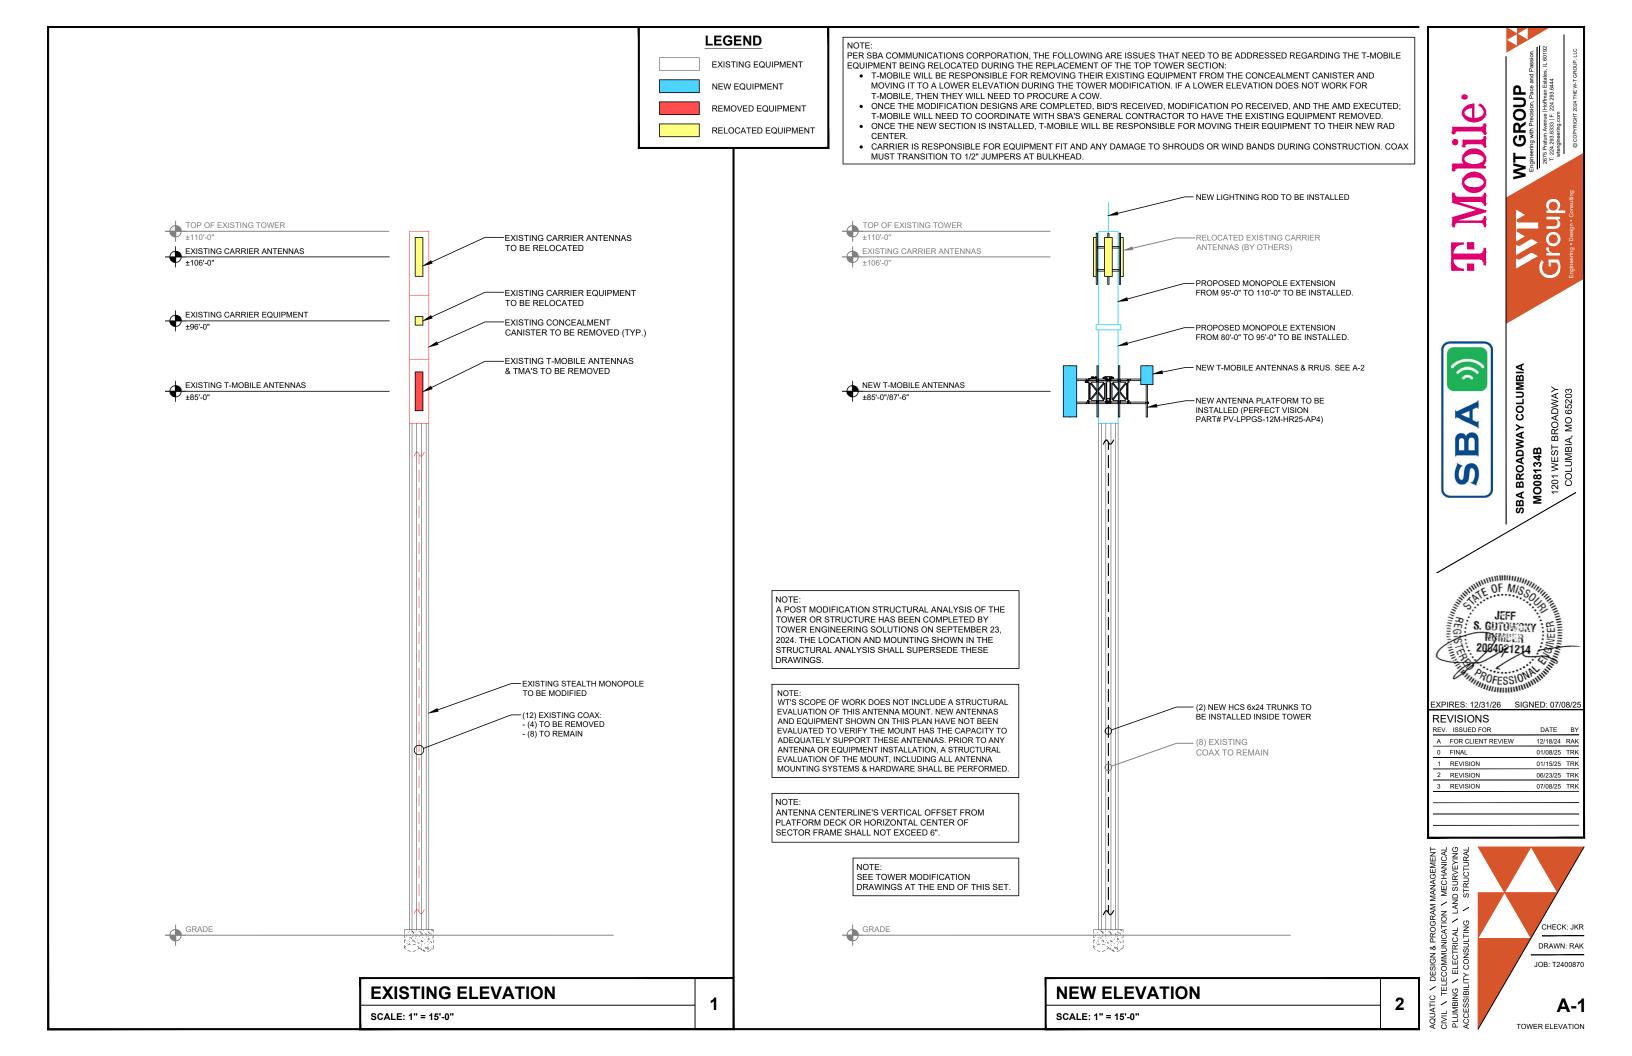

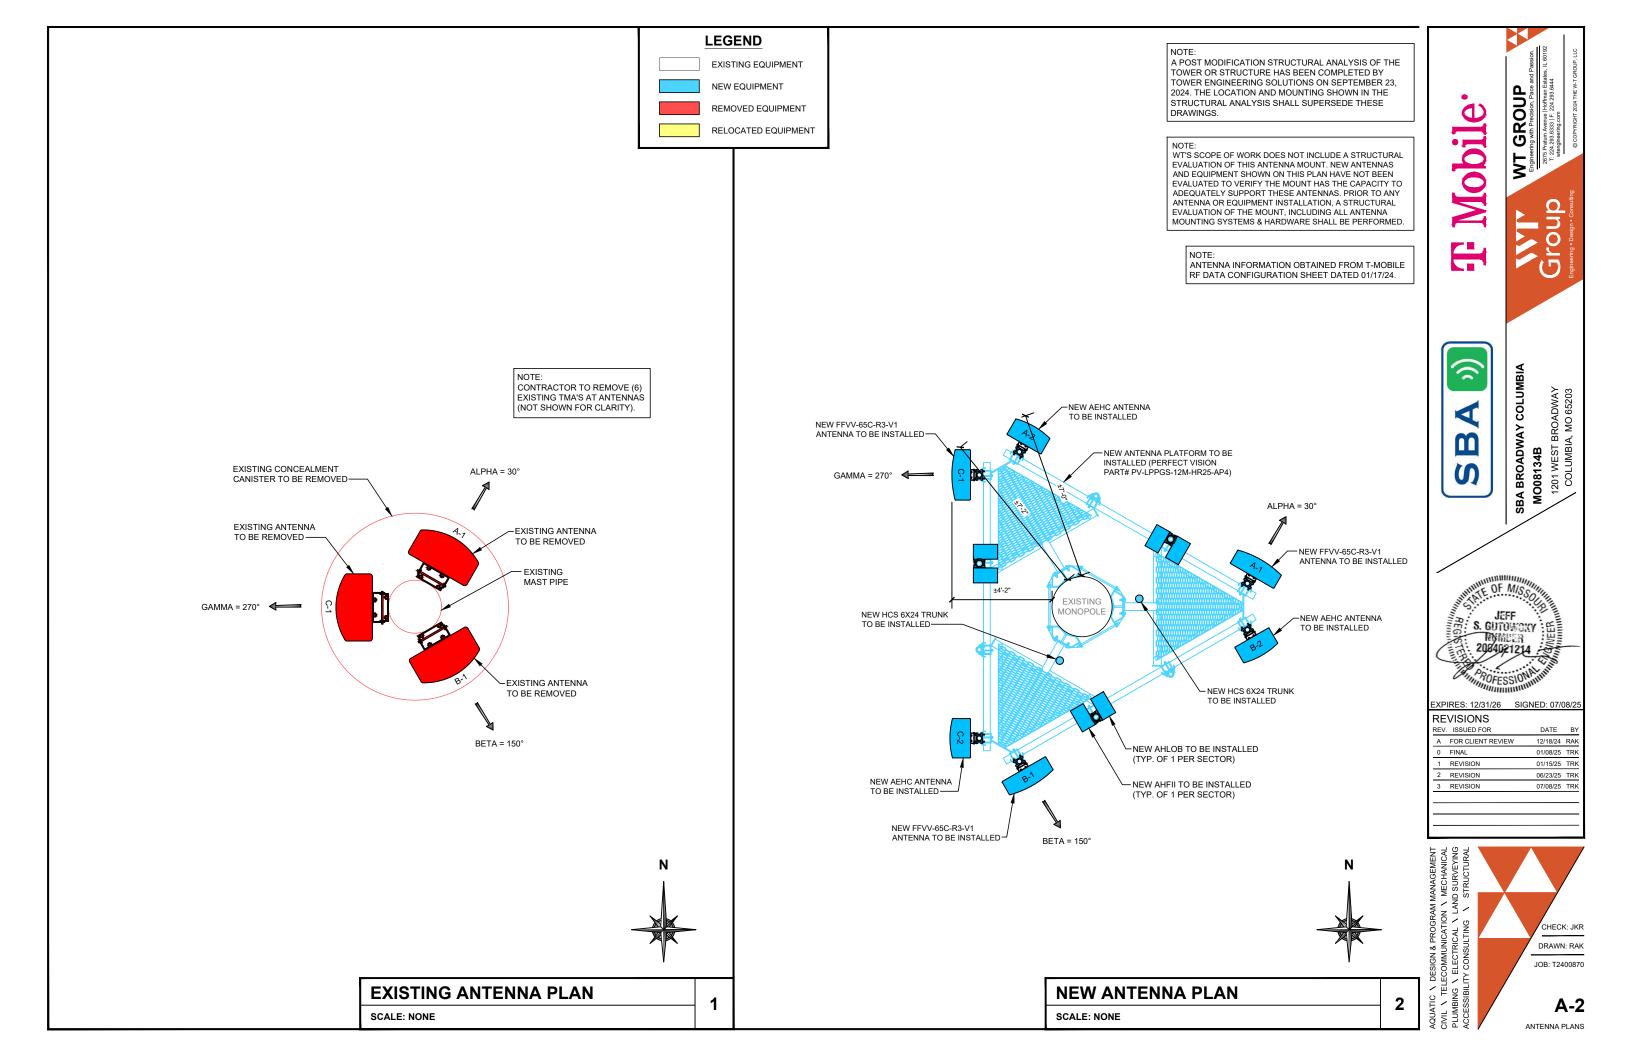

ANTENNA & CABLE SCHEDULE								
SECTOR	ALP	ALPHA BETA GAMMA						
LOCATION	A-2	A-1	B-2	B-1	C-2	C-1		
TECHNOLOGY	N2500	LTE 600, N600, LTE PCS, LTE AWS, N1900, N2100	N2500	LTE 600, N600, LTE PCS, LTE AWS, N1900, N2100	N2500	LTE 600, N600, LTE PCS, LTE AWS, N1900, N2100		
AZIMUTH	30	O°	1!	50°	2'	70°		
RAD CENTER	87'-6"	85'-0"	87'-6"	85'-0"	87'-6"	85'-0"		
COLOR CODING			(SEE CHA	RT ON A-4)	•			
MODEL#	AEHC (ACTIVE ANTENNA-MASSIVE MIMO)	COMMSCOPE FFVV-65C-R3-V1 (OCTO)	AEHC (ACTIVE ANTENNA-MASSIVE MIMO)	COMMSCOPE FFVV-65C-R3-V1 (OCTO)	AEHC (ACTIVE ANTENNA-MASSIVE MIMO)	COMMSCOPE FFVV-65C-R3-V1 (OCTO)		
MECHANICAL DOWNTILT	0	0	0	0	0	0		
ELECTRICAL DOWNTILT	-	7,7,7,7	-	7,7,7,7	-	7,7,7,7		
RRU TYPE	AEHC (INTEGRATED)	AHFII / AHLOB	AEHC (INTEGRATED)	AHFII / AHLOB	AEHC (INTEGRATED)	AHFII / AHLOB		
HCS DIA. & TYPE	SHARED HCS 6x24 TRUNK (2 OF 2)	HCS 6x24 TRUNK (1 OF 2)	HCS 6x24 TRUNK (2 OF 2)	SHARED HCS 6x24 TRUNK (1 OF 2)	SHARED HCS 6x24 TRUNK (2 OF 2)	SHARED HCS 6x24 TRUNK (1 OF 2)		
HCS ACTUAL LENGTH	-	±100'-0"	±100'-0"	-	-	-		
HCS FACTORY LENGTH	-	125'-0"	125'-0"	-	-	-		

ACTUAL LENGTH FACTORY

LENGTH

125'-0"

+10% SAFETY

FACTOR

±110'-0"

ACTUAL

LENGTH

±100'-0"

NEW HCS 6x24

TRUNK LENGTH

FROM SSC TO ANTENNA LOCATION

N	\cap T	Ε.


A POST MODIFICATION STRUCTURAL ANALYSIS OF THE TOWER OR STRUCTURE HAS BEEN COMPLETED BY TOWER ENGINEERING SOLUTIONS ON SEPTEMBER 23, 2024. THE LOCATION AND MOUNTING SHOWN IN THE STRUCTURAL ANALYSIS SHALL SUPERSEDE THESE DRAWINGS.

NOTE: WT'S SCOPE OF WORK DOES NOT INCLUDE A STRUCTURAL EVALUATION OF THIS ANTENNA MOUNT. NEW ANTENNAS AND EQUIPMENT SHOWN ON THIS PLAN HAVE NOT BEEN EVALUATED TO VERIFY THE MOUNT HAS THE CAPACITY TO ADEQUATELY SUPPORT THESE ANTENNAS. PRIOR TO ANY ANTENNA OR EQUIPMENT INSTALLATION, A STRUCTURAL EVALUATION OF THE MOUNT, INCLUDING ALL ANTENNA MOUNTING SYSTEMS & HARDWARE SHALL BE PERFORMED.

ANTENNA INFORMATION OBTAINED FROM T-MOBILE RF DATA CONFIGURATION SHEET DATED 01/17/24.



SCALE: NONE

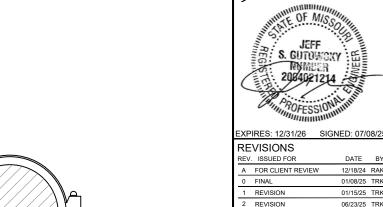

1





3




07/08/25 TRI

WT GROUP

Engineering with Predision, Pace and

SBA BROADWAY COLUMBIA MO08134B

Mobile:

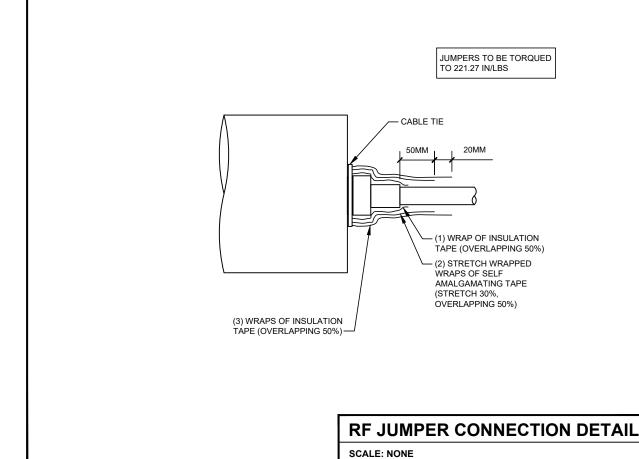

NEW TOWER STANDOFF KIT. SITE PRO PART # STK3 (2) NEW BARREL CÚSHIONS. SITE PRO PART # BC124 -NEW COAX BLOCK MOUNTING HARDWARE. SITE PRO PART# CH50-NEW COAX BLOCK. SITE PRO PART # EXISTING MOUNTING PIPE

RF JUMPER MOUNTING DETAIL

2

SCALE: NONE

NEW HCS 6x24 JUMPERS TO BE ORDERED IN 5M, 10M, OR 20M LENGTHS.

NOTE: CABLE COLOR CODING ON THIS SHEET IS PRELIMINARY AND PENDING FINAL COLOR CODING DESIGN FROM CARRIER.

				HCS 6x	24 (1 of 2)			
	Fiber Pair Ide	entification		Top of Tower		Bottom of towe	r	Comments
Trunk #	Fiber Pair	Bundle Color	Sector	RF Module	RF Port	System Module	BB Port	Technology
1	1	None	Alpha	AHFII1	OPT1			
1	2	None	Alpha	AHFII1	OPT2			
1	3	None	Alpha	AHFII1	OPT3			
1	4	None						
1	5	None	Alpha	AHLOB1	OPT1			
1	6	None	Alpha	AHLOB1	OPT2			
1	7	White	Beta	AHFII2	OPT1		4	
1	8	White	Beta	AHFII2	OPT2		4	
1	9	White	Beta	AHFII2	OPT3		-	
1	10	White					112	b
1	11	White	Beta	AHLOB2	OPT1			
1	12	White	Beta	AHLOB2	OPT2	4		
1	13	Green	Gamma	AHFII3	OPT1			
1	14	Green	Gamma	AHFII3	OPT2		1	
1	15	Green	Gamma	AHFII3	OPT3			
1	16	Green						
1	17	Green	Gamma	AHLOB3	OPT1			
1	18	Green	Gamma	AHLOB3	OPT2			
1	19	Blue						
1	20	Blue		•				
1	21	Blue						
1	22	Blue						
1	23	Blue						
1	24	Blue						


				1100.0	24 (2 52)				
	F11 - B - 1 - 1		_		(24 (2 of 2)				
	Fiber Pair Ide		<u> </u>	Top of Tower			om of towar		Comments
Trunk #	Fiber Pair	Bundle Color	Sector	RF Module	RF Port	System M	'e	l Port	Technology
1	1	None	Alpha	AEHC1	OPT1				
1	2	None	Alpha	AEHC1	OPT2				
1		None	Alpha	AEHC1	OPT3				
1	4	None	Alpha	AEHC1	OPT4				
1	5	None						131	
1	6	None						10.7	
1	7	White	Beta	AEHC2	OPT1				
1	8	White	Beta	AEHC2	OPT2			4	
1	9	White	Beta	AEHC2	OPT3			- 1	
1	10	White	Beta	AEHC2	OPT4			112	
1	11	White							
1	12	White					4	110	
1	13	Green	Gamma	AEHC2	OPT1				
1	14	Green	Gamma	AEHC2	OPT2			-	
1	15	Green	Gamma	AEHC2	OPT3		-1//		
1	16	Green	Gamma	AEHC2	OPT4	-		- N	
1	17	Green							
1	18	Green							
1	19	Blue							
1	20	Blue							·
1	21	Blue							
1	22	Blue							
1	23	Blue							
1	24	Blue							

1	Red	Alpha	AHFII1	All HCS trunk lengths
1	Green	Beta	AHFII2	All HCS trunk lengths
1	Blue	Gamma	AHFII3	All HCS trunk lengths
1	Yellow	Alpha	AHLOB1	For 80m and longer
1	White	Beta	AHLOB2	For 80m and longer
1	Black	Gamma	AHLBO3	For 80m and longer

HCS 6X24 (1 OF 2)

Trunk # DC Pair Color Sector RF Module

	HCS 6X24 (2 OF 2)					
Trunk #	DC Pair Color	Sector	RF Module	HCS Trunk Lengths Where Booster Required		
1	Red	Alpha	AEHC1	For 20m and longer		
1	Green	Beta	AEHC2	For 20m and longer		
1	Blue	Gamma	AEHC3	For 20m and longer		
1	Yellow			·		
1	White					
1	Black					

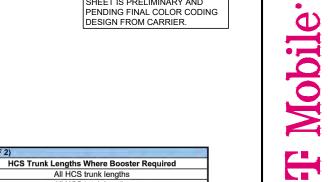



Engineering with Precision, Pace and Engineering with Precision, Pace and 2875 Pratum Avenue Hoffman Estate T. 224, 293 814.4



EXP	IRES: 12/31/26	SIGNED: 07/0	08/2
RE	VISIONS		
REV.	ISSUED FOR	DATE	В
Α	FOR CLIENT REVIEW	12/18/24	RAI
0	FINAL	01/08/25	TRI
1	REVISION	01/15/25	TRI
2	REVISION	06/23/25	TRI
3	REVISION	07/08/25	TRI

CHECK: JKR DRAWN: RAK JOB: T2400870 **A-4** EQUIPMENT DETAILS


HCS 6x24 COLOR CODING

SCALE: NONE

1

Configuration 56790EBH_SR_T_6x24

* For 5G and LTE Airscale BB dimensioning refer to Fiber Port matrices. (Alpha, Beta & Gamma)

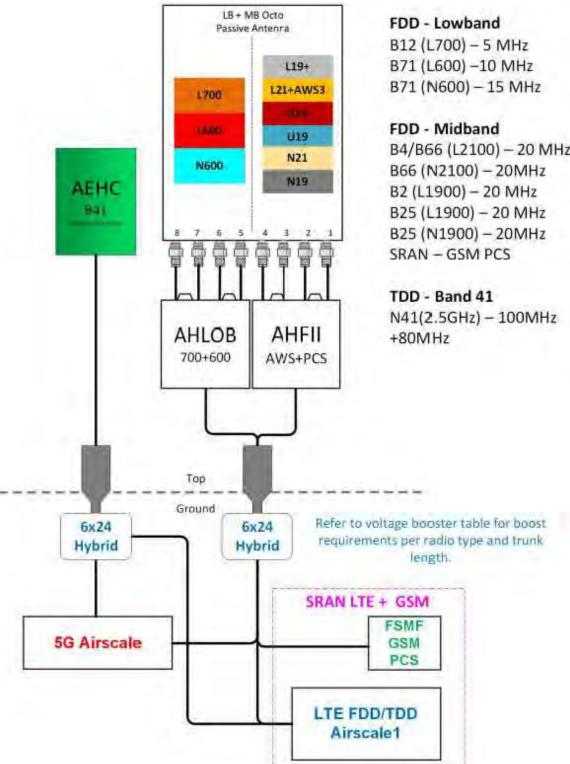

B4/B66 (L2100) - 20 MHz

1

REVISIONS

1 REVISION

2 REVISION

A FOR CLIENT REVIEW

07/08/25 TRI . CHECK: JKR DRAWN: RAK JOB: T2400870

WT GROUP

Engineering with Prediston, Pace an

Zord Prentum Autorie (Hoffman East

To 204, 204, 63331 | F. 204, 209, 6444

SBA BROADWAY COLUMBIA
MO08134B
1201 WEST BROADWAY
COLUMBIA, MO 65203

Mobile:

m

S

RF PLUMBING DIAGRAM

SCALE: NONE


A-5 EQUIPMENT DETAILS


12/18/24 RAK

01/08/25 TRF

01/15/25 TR

06/23/25 TRK

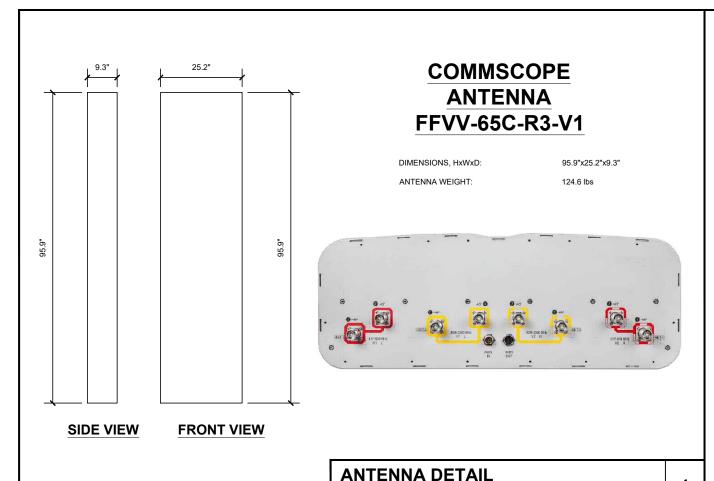

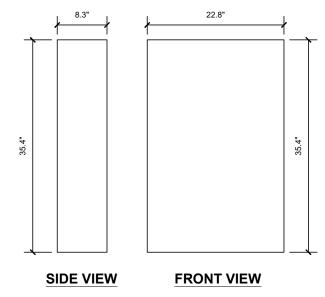

NOKIA ANTENNA AEHC AIRSCALE

DIMENSIONS, HxWxD: 35.4"x22.8"x8.3" ANTENNA WEIGHT: 99.2 lbs




ANTENNA DETAIL

SCALE: NONE

2

RRH Product name Nokia AHLOB AirScale RRH 4T4R B71/85 320W 475910A Model number Rated max Tx power 320 W 4TX4RX Number of TXRX Beamforming 3GPP compliant, FCC&ISED, FDD-LTE, NR SW supported techno. Frequency range Band 71: RX 663 MHz - 698 MHz, TX 617 MHz - 652 MHz Band 85: RX 698 MHz - 716 MHz, TX 728 MHz – 746 MHz

SCALE: NONE

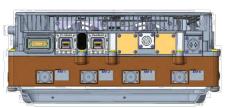





AHLOB DETAIL	
SCALE: NONE	


AHFII AirScale RRH 4T4R B25/66 480W

Technical data

1

3

	Product Specifications
Standard	3GPP compliant
Supported RAT*	2G, 3G, 4G, 5G or combination i.e. 4G/5G, IoT (SA,GB,IB), FDD
Band / Frequency range	Band 25: RX 1850 MHz – 1915 MHz, TX 1930 MHz – 1995 MHz Band 66: RX 1710 MHz – 1780 MHz, TX 2110 MHz – 2200 MHz
Max. supported modulation*	256QAM UL / 1024 QAM DL
Number of TX/RX paths*	4T4R
Instantaneous bandwidth (IBW)*	Full band
Occupied bandwidth (OBW)*	Full band, OBW B25 65MHz (UL/DL), B66 70MHz (UL) 90MHz (DL)
Max. RF output power*	4x80W in any band while 4x40W in other band
Dimensions (H×W×D)	641 x 342 x 115 mm (core), 676 x 369 x 145 mm (envelope)
Volume	25 L
Weight (excluding mounting bracket)	32 kg**
Supply voltage / Connector type	DC -40.5 V60 V / Nokia 2 pole connector
Antenna ports	4 x 4.3-10
Optical ports*	3 x SF28 Ports CPRI 9.8 Gbps (Rate 7)
Other interfaces / Connector type	RET RS485, AISG 3.0, EAC MDR26
Operational temperature range	-40 °C +55 °C
Cooling	Forced Convection (fans)
Installation options	Pole, wall, rail
Ingress / Surge protection	IP65, DC Power Port: 20 kA 8/20 µs

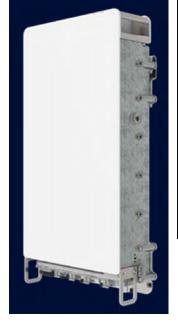

AQUATIC \ DESIGN & PROGRAM MANAGEMENT CIVIL \ TELECOMMUNICATION \ MECHANICAL PLUMBING \ ELECTRICAL \ LAND SURVEYING ACCESSIBILITY CONSULTING \ STRUCTURAL

4

. CHECK: JKR DRAWN: RAK JOB: T2400870 **A-6** EQUIPMENT DETAILS

* = 25.2" x 13.5" x 4	.5"
** = 70.5 lbs	

AHFII DETAIL	
SCALE: NONE	

Mobile:

WT GROUP

SBA BROADWAY COLUMBIA MO08134B


111LO. 12/31/20	CICIVED. 01/0
EVISIONS	
V. ISSUED FOR	DATE
FOR CLIENT REVIEW	/ 12/18/24
FINAL	01/08/25
REVISION	01/15/25
REVISION	06/23/25
REVISION	07/08/25


Nokia AirScale System Module Indoor consists of the following items:

- One Nokia AirScale Subrack (AMIA), including backplane for high bandwidth connectivity between processing plug-in units
- One or two Nokia AirScale Common (ASIA) plug-in units for transport interfacing and for centralized processing
- Up to six Nokia AirScale Capacity (ABIA) plug-in units for baseband processing and for optical interfaces with radio units


Weight Empty: 5.1 kg (11.2 lb) With dummy panels: 6.8 kg (15 lb) With all units: 23.9 kg (52.7 lb)


The AirScale Subrack (AMIA) has a 3U height and fits into a standard 19 in. rack. Multiple subracks can be stacked on top of each other. The indoor subrack includes fans, a backplane for internal communication, and the DC-feed. The direction of the cooling air can be changed by rotating fans. The default direction is front-to-back.

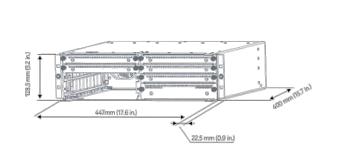

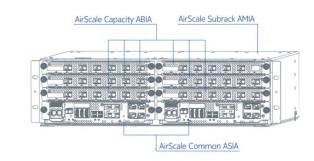


AMIA DETAIL	
SCALE: NONE	

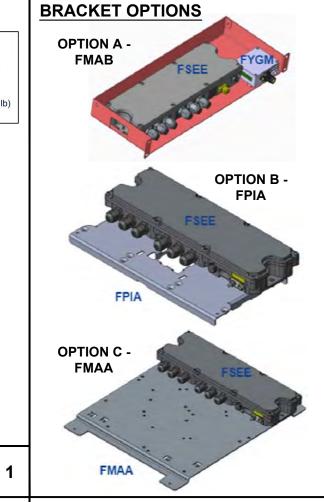

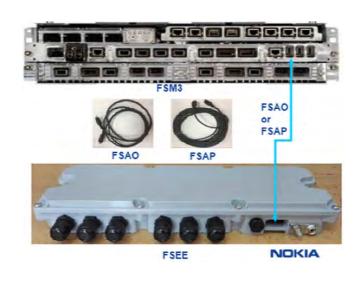

ſ	FSEE DETAIL	2
ſ	SCALE: NONE	

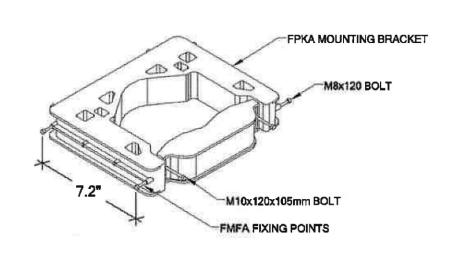

FPKA MOUNTING BRACKET DETAIL

SCALE: NONE


NOT USED SCALE: NONE

. CHECK: JKR DRAWN: RAK JOB: T2400870 **A-7** EQUIPMENT DETAILS

WT GROUP

Engineering with Predision, Pace an Mobile

SBA BROADWAY COLUMBIA MO08134B

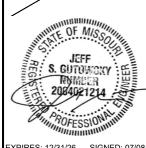


	IRES: 12/31/20	SIGNED: 07/00
RE	VISIONS	
REV.	ISSUED FOR	DATE
Α	FOR CLIENT REVIEW	12/18/24 F
0	FINAL	01/08/25
1	REVISION	01/15/25
2	REVISION	06/23/25
3	REVISION	07/08/25

HUBER+SUHNER

19" Flexbox (extendable) Flexbox-19" 1U trunk enclosure 24 x LC D Singlemode UPC/APC and Multimode OM4



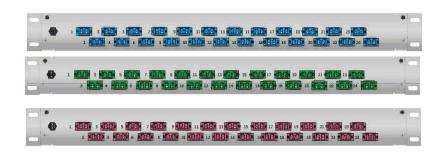

FIBER TRAY DETAIL

SCALE: NONE

FLOOR MOUNT

RACK MOUNT

EXPANSION PLATE

SPD TRAY DETAIL

SCALE: NONE

(AS-NEEDED)

2

RE'	VISIONS		
REV.	ISSUED FOR	DATE	BY
Α	FOR CLIENT REVIEW	12/18/24	RAK
0	FINAL	01/08/25	TRK
1	REVISION	01/15/25	TRK
2	REVISION	06/23/25	TRK
3	REVISION	07/08/25	TRK
	-		

SBA BROADWAY COLUMBIA MO08134B

WT GROUP

Mobile

DRAWN: RAK JOB: T2400870 EQUIPMENT DETAILS

A-8

MANUFACTURER AND PART # OF NEW VOLTAGE BOOSTER TO BE VERIFIED.

Upconverter



Breaker Configs Supported

HCS 6x24: 6 x 40A†

HCS 2.0: 3 x 80A*†

HCS 1.0: 1 x 200A*

VOLTAGE BOOSTER DETAIL

SCALE: NONE


3


1


SCALE: NONE


NOT USED

Nokia SSC SKU # 34816

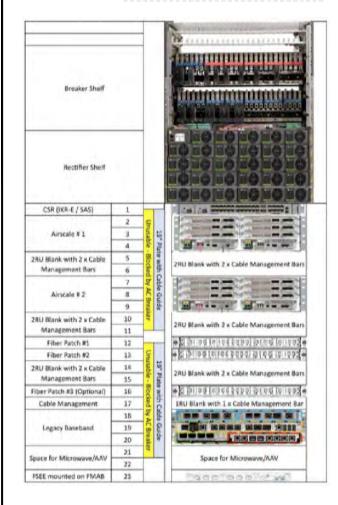

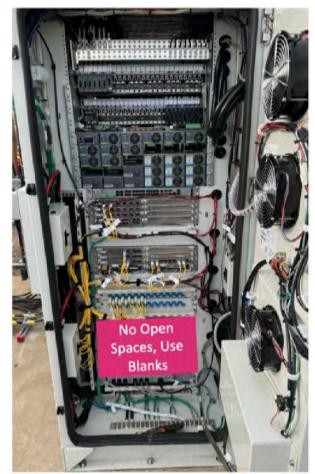


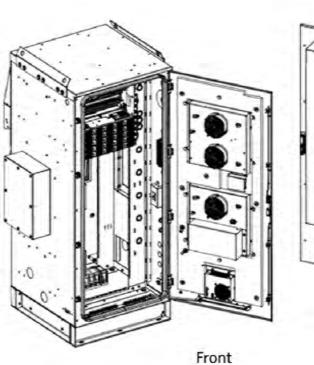


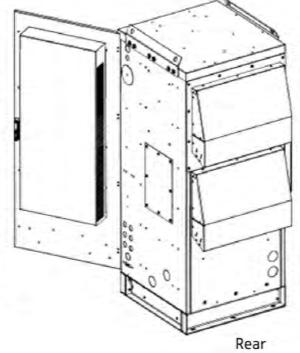

SCALE: NONE

1

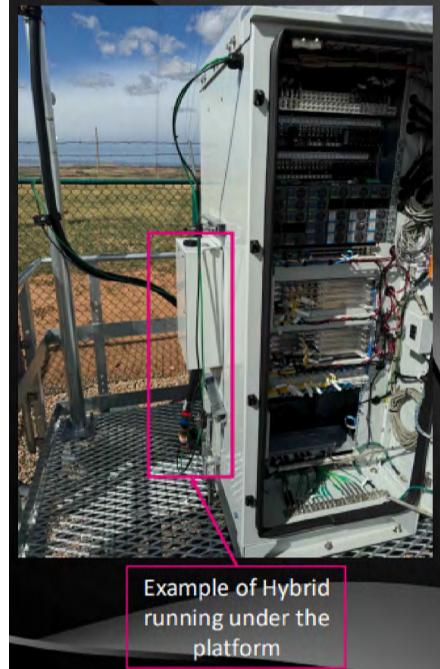

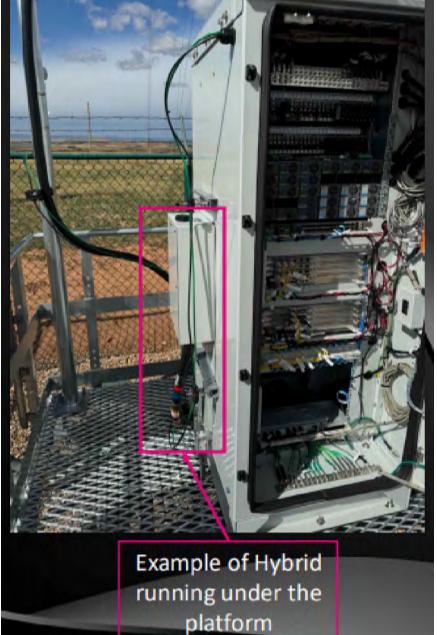

SCALE: NONE

HCS 6x24 TRUNK ENTRY DETAIL

2

REVISIONS

1 REVISION

2 REVISION

A FOR CLIENT REVIEW

DRAWN: RAK JOB: T2400870 **A-9** EQUIPMENT DETAILS

WT GROUP

SBA BROADWAY COLUMBIA MO08134B

12/18/24 RAK

01/08/25 TRF

01/15/25 TRK


06/23/25 TRK


07/08/25 TRI

. CHECK: JKR

Mobile:

NOKIA

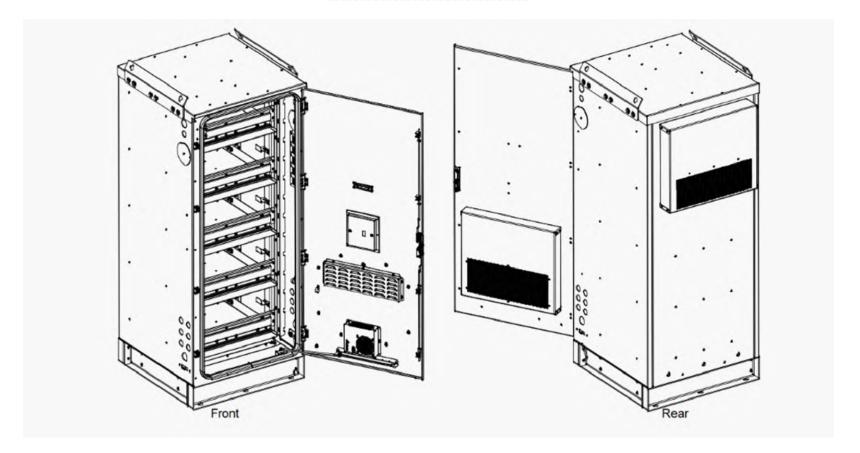

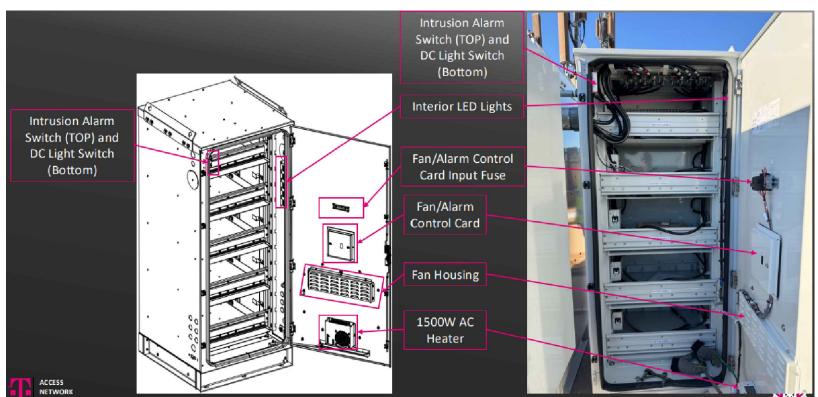




SCALE: NONE

WT GROUP

Engineering with Prediston, Pace an
2675 Pratum Avenue Hoffman Esta Mobile:





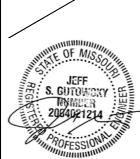

EXP	IRES: 12/31/26	SIGNED: 07/0	08/2
RE	VISIONS		
REV	. ISSUED FOR	DATE	В
Α	FOR CLIENT REVIEW	12/18/24	RA
0	FINAL	01/08/25	TRI
1	REVISION	01/15/25	TRI
2	REVISION	06/23/25	TRI
3	REVISION	07/08/25	TRI
_			



1



Power Protection Cabinet (PPC) 225A with Generator Input and AC Alarm

Product Features


- Single wall Aluminum enclosure
- Powder coated finish
- Pad lockable 3-point door latch
- Type 3R & IP55 rated
- Metal oxide varistor surge protection
- Camlok generator connection
- Main AC Input Detection Alarm





Specifications

Model / Part Number	4910163600	
1. General		Delta Group Website:
Construction	Single layer Aluminum enclosure, Type 3R	www.deltaww.com
Dii AM -II D)	20.2 x 39 x 11.2 inch excludes generator connections	Product Website:
Dimensions (W x H x D)	29.7 x 39 x 11.2 inch including RH Camlok generator box	www.deltapowersolutions.com
Weight	71 lbs (without packaging)	www.deitapowersolutions.com
Finish	Polyester Powder Paint	United States of America & Canada:
Door Latch	3-Point latching, pad lockable	Delta Electronics (USA) Inc.
	UL50 (Cabinet)	2925 E. Plano Parkway
0-1-1	UL891 Dead Front Switchboard Listed	Plano, TX (Texas) 75074
Safety	Suitable for Use as Service Equipment (N-G Bonding kit included)	Sales and Orders:
2. Environment		DEUSTPS.Sales@deltaww.com
Operating temperature	-40°C to +46°C (-40°F to 115°F)	DEUSTPS.Orders@deltaww.com
Humidity (relative)	95%, non-condensing (Max.)	DECOTT C. Ordoro@doi.dww.com
Protection class	Type 3R	Field Support:
3. AC Section		1-877-DELTA-08 option 3
Voltage	240/120 Single Phase (3 wire + Ground)	(877-335-8208 option 3)
Current	225A	
AIC Rating	Utility 65,000 Amps	DEUSTPS.Support@deltaww.com
	Generator Interface: Camlok Connections (Right Mount)	Installation Services:
	Service Disconnect: Square D 225 Amp (65kAlC) Mechanical Slide Bar Interlock	DEUSTPS.Services@deltaww.com
	Load Center: Square D 225 Amp, QO Series, 24 Position	RMA:
011 6 1	Surge Protection Device (SPD) - 1 ea. AC2080M-02	DEUSTPS.RMA@deltaww.com
Other features	Square D 30 Amp, 2-Pole Breaker for SPD	220011 011 111 16 001 1111 10
	Ground Bar	
	Silkscreen Dead-Front Lift Off Style	
	Captive Dead-Front Fasteners	
	Loss of AC Input Alarm	
5. Ordering information		
PPC	4910163600 Power Pedestal Cabinet - 225A w/ AC Alarm	

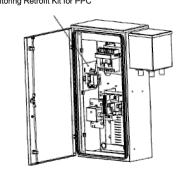





AC Alarm Relay Kit FRU


GENERATOR INPUT

*Male Receptacle Twist Lock Panel Mount connectors (not included)

*All specifications are subject to change without prior notice.

EN_z23n2P17/FH

	www.deltapowersolutions.com
Unit	ed States of America & Canada:
	Delta Electronics (USA) Inc.
	2925 E. Plano Parkway
	Plano, TX (Texas) 75074
Sale	s and Orders:
	DEUSTPS.Sales@deltaww.com
	DEUSTPS.Orders@deltaww.com
Field	d Support:
	1-877-DELTA-08 option 3
	(877-335-8208 option 3)
	DEUSTPS.Support@deltaww.com
Insta	allation Services:
	DEUSTPS.Services@deltaww.com
RMA	1 :
	DEUSTPS.RMA@deltaww.com

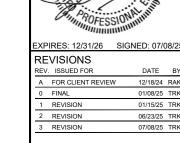


Mobile:

DRAWN: RAK JOB: T2400870 **A-11** EQUIPMENT DETAILS

PPC DETAIL

SCALE: NONE

www.deltaww.com

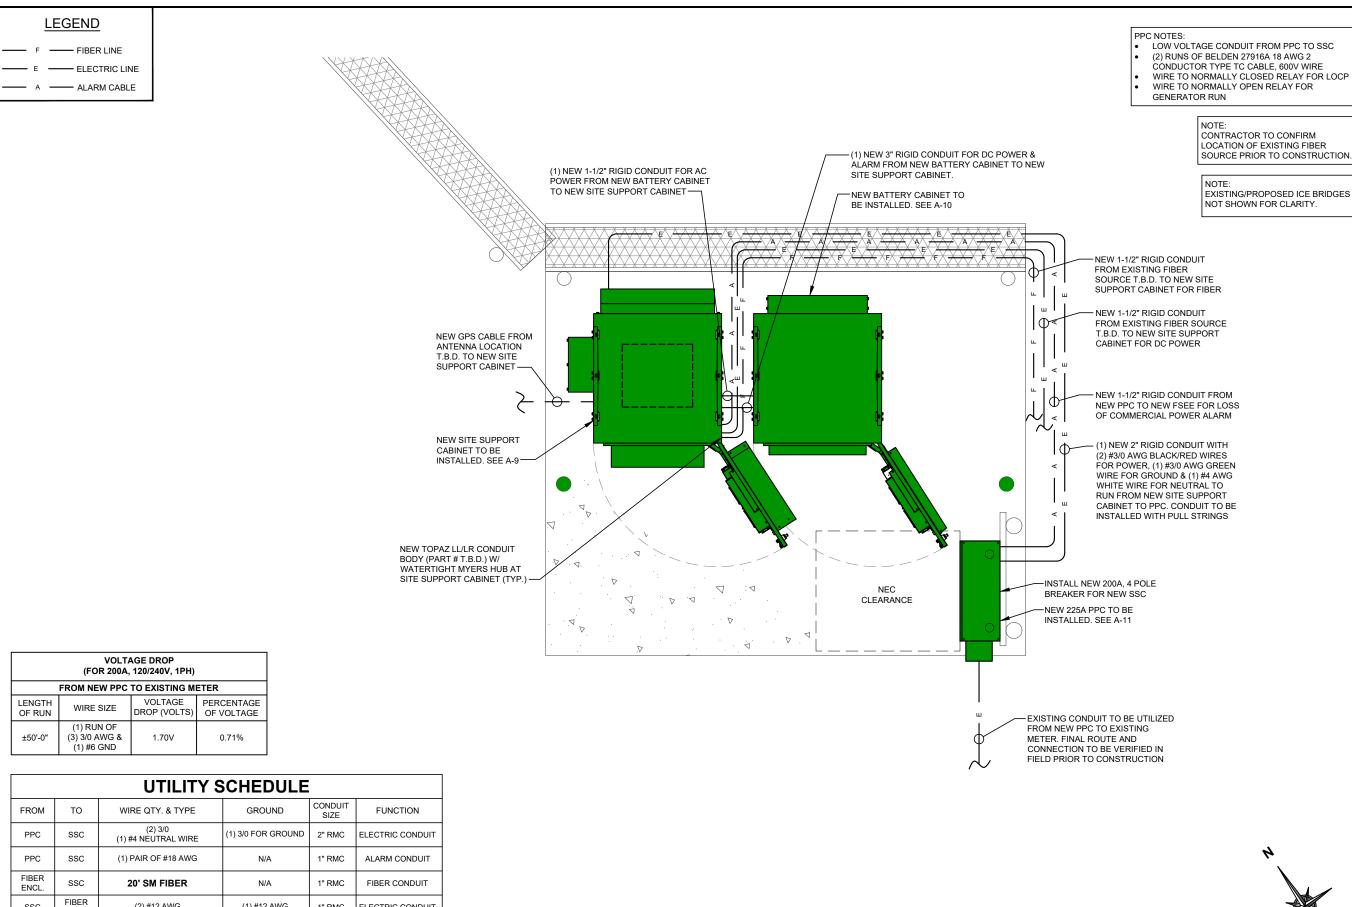

ACTUAL LENGTH

+10% SAFETY

FACTOR

LENGTH

GPS ANTENNA CABLE LENGTH

FACTORY

LENGTH

98'-5"

(30m)

SSC

BATTERY

CABINET

SSC

BATTERY

CABINET

ENCL

SSC

BATTERY

CARINET

SSC

(2) #12 AWG

(2) CAT-5 CABLES

(2) PAIRS OF 4/0 TELCO FLEX

OWER CABLES & (3) #12 AWG

(1) #12 AWG

N/A

ELECTRIC CONDUIT

TELCO CONDUIT

ELECTRIC CONDUIT

ELECTRIC +

ALARM CONDUIT

1" RMC

3" RMC



UTILITY PLAN 1 SCALE: 1/2" = 1'-0"

REVISIONS

REV. ISSUED FOR

1 REVISION

2 REVISION

3 REVISION

A FOR CLIENT REVIEW

CHECK: JKR DRAWN: RAK JOB: T2400870

WT GROUP

Engineering with Predision, Pace an

SBA BROADWAY COLUMBIA

S. GUTOWSKY

m

Mobile:

E-1 LITILITY PLAN

12/18/24 RAM

01/08/25 TRI

01/15/25 TR

06/23/25 TRI

07/08/25 TRI

SITE NUM	MBER:	T-Mobile				MODEL N	JMBER:	4910163600							
VOLTAGE	E:	240V/120				PHASE:		1 WIRE: 3					3		
MAIN BRI	EAKER:	200 AMP				BUSS RAT	ING:	225 AMPS		AIC:			65,000		
MOUNT:		SURFACE				NEUTRAL	BAR:	YES		GROUND E	BAR:		YES		
ENCLOSU	URE TYPE:	NEMA 3R				N to GROU	IND BOND:	YES							
PANEL S	TATUS:	NEW				INTERNAL		YES							
СКТ	LOAD DESCRIPTION	BREAKER AMPS	BREAKER POLES	BREAKER STATUS	SERVICE LOAD VA		PHASE A VA	PHASE B VA	USAGE FACTOR	LOAD VA	BREAKER STATUS	BREAKER POLES	BREAKER AMPS	LOAD DESCRIPTION	скт
1	SURGE ARRESTOR	60	2	ON	0	1.00	9525		1.25	9525	ON	2	150	SITE SUPPORT CABINET	2
3	SUNGE ARRES TUR	00	2	ON	0	1.00		9525	1.25	9525	ON		130	SITE SUFFURT CADINET	4
5	SERVICE LIGHT (IF INSTALLED)	15	1	ON	30	1.00	9555		0.00	0	N/A				6
7				N/A	0	0.00		0	0.00	0	N/A				8
9				N/A	0	0.00	0		0.00	0	N/A				10
11				N/A	0	0.00		0	0.00	0	N/A				12
13				N/A	0	0.00	0		0.00	0	N/A				14
15				N/A	0	0.00		0	0.00	0	N/A				16
17		-		N/A	0	0.00	0		0.00	0	N/A				18
19				N/A	0	0.00		0	0.00	0	N/A				20
21				N/A	0	0.00	0		0.00	0	N/A				22
23		-		N/A	0	0.00		0	1.00	180	ON	1	20	GFI	24
							19080	9525	VA			TOTAL KVA	28.61		
												AMPS	119.19		

PANEL SCHEDULE	1
SCALE: NONE	•

NOT USED

SCALE: NONE

WT GROUP

Engineering with Predsion, Pace and

STST Pratum Avenue | Hoffman Estat

T. 292, 293 Racks | F. 292, 293 Racks T Mobile.



SBA BROADWAY COLUMBIA
MO08134B
1201 WEST BROADWAY
COLUMBIA, MO 65203



EXP	IRES: 12/31/26	SIGNED: 07/0)8/
RE	VISIONS		
REV.	ISSUED FOR	DATE	E
Α	FOR CLIENT REVIEW	12/18/24	R
0	FINAL	01/08/25	TF
1	REVISION	01/15/25	TF
2	REVISION	06/23/25	TF
3	REVISION	07/08/25	TF
		_	

CHECK: JKR DRAWN: RAK JOB: T2400870 E-2

3

ELECTRICAL DETAILS


NOT USED SCALE: NONE


2

NOTES:

- ALL ELECTRICAL WORK SHALL CONFORM TO THE LOCAL ELECTRICAL CODE (EDITION ADOPTED BY LOCAL JURISDICTION) AND APPLICABLE LOCAL CODES
- GROUNDING SHALL COMPLY WITH THE LOCAL ELECTRICAL CODE.
- ALL ELECTRICAL ITEMS SHALL BE U.L. APPROVED OR LISTED.
- WIRES AND CABLES FOR POWER AND LIGHTING SHALL BE COPPER WITH TYPE XHHW, THWN, OR THHN INSULATION. SOLID CONDUCTORS FOR #10 AWG AND SMALLER, STRANDED FOR LARGER THAN #10 AWG. MINIMUM SIZE #12 AWG.
- WIRES AND CABLES FOR POWER SHALL BE INSTALLED IN GALVANIZED RIGID STEEL CONDUIT OR FLEXIBLE LIQUID TIGHT CONDUIT AS INDICATED ON DRAWING.
- CONTRACTOR TO OBTAIN ALL PERMITS, PAY PERMIT FEES, AND BE RESPONSIBLE FOR SCHEDULING INSPECTIONS.
- COORDINATE WITH UTILITY COMPANIES SERVICE ENTRANCE REQUIREMENTS.
- PROVIDE ALL LABOR AND MATERIAL DESCRIBED ON THIS DRAWING, AND ALL ITEMS INCIDENTAL TO COMPLETING AND PRESENTING THIS PROJECT AS FULLY
- GROUNDING CONNECTIONS SHALL BE EXOTHERMIC TYPE TO ANTENNA MASTS, AND THE GROUND BARS. REMAINING GROUNDING CONNECTIONS SHALL BE
- GROUND COAXIAL CABLE SHIELDS AT BOTH ENDS WITH COAX CABLE GROUNDING 10. KITS & INSTALL WEATHER PROOFING KIT AT EACH CONNECTION.
- ROUTE GROUNDING CONDUCTORS ALONG THE SHORTEST AND STRAIGHTEST PATH POSSIBLE, EXCEPT AS OTHERWISE INDICATED. GROUNDING LEADS SHOULD NEVER BE BENT AT RIGHT ANGLE. ALWAYS MAKE AT LEAST 12" RADIUS BENDS. #6 WIRE CAN BE BENT AT 6" RADIUS WHEN NECESSARY
- 12. CONTRACTOR TO PROVIDE GROUND RING AS SHOWN ON GROUNDING SITE PLAN AND GROUNDING RISER DIAGRAM. CONTRACTOR SHALL TEST AND VERIFY THAT THE IMPEDANCE DOES NOT EXCEED 5 OHMS TO GROUND BY MEANS OF A BIDDLE-MEGGER TESTER. GROUNDING AND OTHER OPERATIONAL TESTING SHALL SHALL BE WITNESSED BY THE OWNER'S REPRESENTATIVE.
- 13. CONTRACTOR TO PROVIDE TELEPHONE CONDUIT AS SHOWN ON PLANS.
- CONTRACTOR TO PROVIDE ELECTRIC CONDUIT AS SHOWN ON PLANS.
- 15. NOTIFY LOCAL UTILITY SERVICE PRIOR TO ANY INSTALLATION.
- ALL EQUIPMENT FURNISHED BY OTHERS SHALL BE PROVIDED WITH PROPER MOTOR STARTERS, DISCONNECTS, CONTROLS, ETC. BY THE ELECTRICAL CONTRACTOR UNLESS SPECIFICALLY NOTED OTHERWISE. THE ELECTRICAL CONTRACTOR SHALL INSTALL AND COMPLETELY WIRE ALL ASSOCIATED EQUIPMENT IN ACCORDANCE WITH MANUFACTURER'S WIRE DIAGRAMS AND AS REQUIRED FOR A COMPLETE OPERATING INSTALLATION. ELECTRICAL CONTRACTOR SHALL VERIFY AND COORDINATE ELECTRICAL CHARACTERISTICS AND REQUIREMENTS OF EQUIPMENT PRIOR TO ROUGH-IN OF CONDUIT AND WIRING TO AVOID CONFLICTS WHERE APPLICABLE.
- GROUNDING CONDUCTORS SHALL BE COPPER OR SOLID TINNED COPPER. ALL CONNECTIONS MADE BELOW GRADE SHALL BE SOLID TINNED COPPER. ALL CONNECTIONS ABOVE GRADE STRANDED IS PERMITTED. BUS BARS TO BE TIN
- ALL EXOTHERMIC WELDS ABOVE FINISHED GRADE SHALL BE PAINTED WITH CO-GALVANIZED ZINC ENRICHED PAINT TO MATCH COLOR OBJECT BONDED TO.
- CONNECT COAX GROUND KITS TO MASTER GROUND BAR AT BASE OF TOWER.
- 20 CONNECT COAX GROUND KITS TO GROUND BUS AT TOP OF TOWER
- 21. CONNECT LNA GROUND TO GROUND BUS AT TOP OF TOWER.
- ALL GROUNDING CONNECTIONS TO BE MADE USING EXOTHERMIC WELD PROCESS 22. UNLESS OTHERWISE APPROVED BY DESIGNER.
- 23. ELECTRICAL CONTRACTOR TO PULL BONDING JUMPER AT CABINET ONLY IF DISCONNECT GROUND IS TIED TO GROUND FIELD INSTEAD OF SEPARATE GROUND ROD
- PLAN DRAWINGS SHOWN HEREIN DO NOT NECESSARILY DEPICT ELECTRICAL REQUIREMENTS OF INDIVIDUAL EQUIPMENT AND DEVICES SUCH AS THE EQUIPMENT GROUNDING REQUIREMENTS, POWER REQUIREMENTS AND TELCO
- 25. PLAN DRAWINGS SHOWN HEREIN ARE DIAGRAMMATIC AND DO NOT NECESSARILY DEPICT THE EXACT EQUIPMENT QUANTITIES, LOCATION, LAYOUT AND CONFIGURATION. REFER TO ARCHITECTURAL PLANS FOR EXACT EQUIPMENT LOCATION, LAYOUT AND CONFIGURATION.
- 26. REFER TO ARCHITECTURAL PLANS FOR THE LOCATION OF POWER AND TELCO POINT OF CONNECTIONS, THE DISTANCE OF THE RUN, AND THE SUGGESTED CONDUIT ROUTING. FIELD VERIFY EXISTING CONDITIONS SPECIFICALLY FOR CONDUIT ROUTING PRIOR TO BID.
- NUMBER OF ANTENNAS REPRESENTED IN THIS DETAIL ARE FOR SHOWING 27. CLARITY OF GROUND SYSTEM REQUIREMENTS ONLY. SEE RF INFO FOR ANTENNA
- 28. CONTRACTOR TO 'NOALOX' ALL CONNECTIONS TO GROUND BARS.
- 29. ALL GROUND WIRES ENTERING GROUND SHALL HAVE PVC SLEEVE.

ANTENNA SECTOR

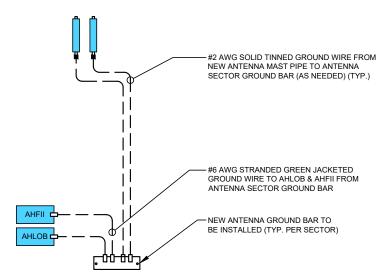


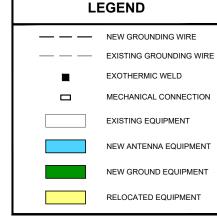

NOTES:

- AMIA TO CABINET GROUND BAR: #6 AWG STRANDED GREEN JACKETED GROUND WIRE
- FSEE TO CABINET GROUND BAR: #6 AWG STRANDED GREEN JACKETED GROUND WIRE
- CABINETS TO GROUND RING: #2 SOLID TINNED COPPER GROUND WIRE IN 1/2" NON METALLIC SEALTIGHT WITH NO-OX, AND CAULKED
- CABINET GROUND BAR TO GROUND RING: #2 SOLID TINNED COPPER GROUND WIRE IN 1/2" NON METALLIC SEALTIGHT WITH NO-OX, AND CAULKED
- PPC TO GROUND RING: #2 AWG SOLID TINNED COPPER GROUND WIRE IN 1/2" NON-METALLIC SEALTIGHT WITH NO-OX AND CAULKED
- ICE BRIDGE POST TO GROUND RING: #2 AWG SOLID TINNED COPPER GROUND WIRE IN 1/2" NON-METALLIC SEALTIGHT WITH NO-OX AND CAULKED

CONTRACTOR TO VERIFY FINAL GROUNDING SYSTEM RESISTANCE TO BE UNDER 5 OHMs

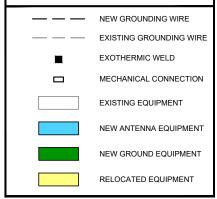




SBA BROADWAY COLUMBIA

WT GROUP


Mobile

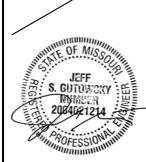

	Ĭ	II (LO. 12/31/20	GIGINED. 0170	JU/ 2
	RE	VISIONS		
	REV.	ISSUED FOR	DATE	В
	Α	FOR CLIENT REVIEW	12/18/24	RA
	0	FINAL	01/08/25	TR
	1	REVISION	01/15/25	TR
	2	REVISION	06/23/25	TR
ı	3	REVISION	07/08/25	TR



1

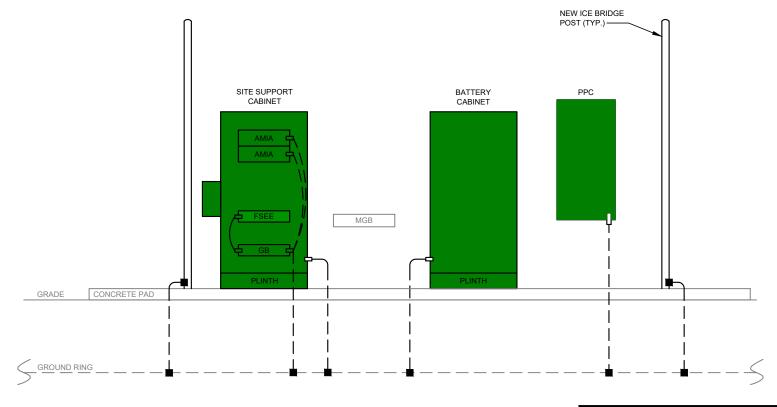


GROUNDING RISER SCALE: NONE

GR-1 GROUNDING RISER

CHECK: JKR

DRAWN: RAK

JOB: T2400870

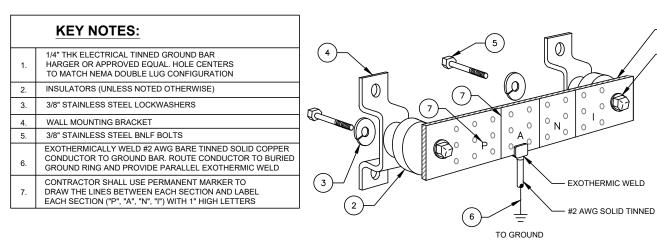

EACH GROUND CONDUCTOR TERMINATING ON ANY GROUND BAR SHALL HAVE AN IDENTIFICATION TAG ATTACHED AT EACH END THAT WILL IDENTIFY ITS ORIGIN AND DESTINATION

SECTION "P" - SURGE PRODUCERS

- COLLECTOR GROUND BAR
- GENERATOR FRAMEWORK (IF AVAILABLE)
- COMMERCIAL POWER COMMON NEUTRAL/GROUND
- FIBER GROUND BAR
- EQUIPMENT ROOM COLLECTOR GROUND BAR
- HVAC
- RECTIFIER FRAMES

SECTION "A" - SURGE ABSORBERS

INTERIOR GROUND RING

- EXTERNAL EARTH GROUND FIELD (BURIED GROUND
- METALLIC COLD WATER PIPE (IF AVAILABLE) BUILDING STEEL (IF AVAILABLE)

SECTION "N" - NON-ISOLATED GROUND ZONE EQUIPMENT MISCELLANEOUS NON-ISOLATED GROUND ZONE

- EQUIPMENT
- CABLE TRAY SYSTEM EQUIPMENT FRAMES
- BATTERY RACKS
- DC POWER

SECTION "I" - ISOLATED GROUND ZONE ISOLATED EQUIPMENT FRAMES

ISOLATED GROUND BAR - IGB

-EXTERIOR GROUND BARS TO BE TIN PLATED

-HARDWARE SHALL BE STAINLESS STEEL -CONTRACTOR SHALL GROUP INCOMING

USE THEFT

FASTENERS ON


ALL GROUND

PROOF

BARS COMMSCOPE

PART# MTC9674KEY

-CONTRACTOR TO APPLY 'KOPR-SHIELD' TO ALL CONNECTIONS

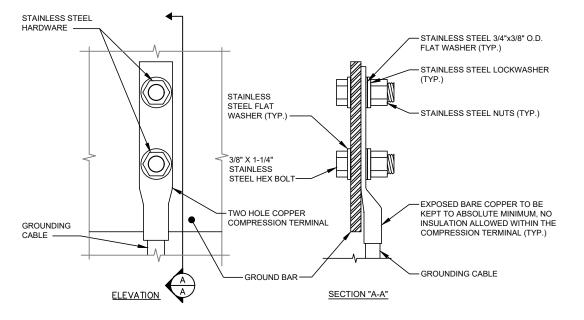

OXIDE INHIBITING COMPOUND TO BE USED AT ALL LOCATIONS NO CRIMPING OF SOLID #2. USE EXOTHERMIC WELD ONLY

GROUND BAR CONNECTION DETAIL

SCALE: NONE

2

S. GUTOWSKY

WT GROUP

Engineering with Predsion, Pace an

SBA BROADWAY COLUMBIA

Mobile


Е	ΧP	IRES: 12/31/26	SIGNED: 07/0)8/
F	RΕ	VISIONS		
F	REV.	ISSUED FOR	DATE	E
П	Α	FOR CLIENT REVIEW	12/18/24	R/
Г	0	FINAL	01/08/25	TF
ľ	1	REVISION	01/15/25	TF
L	2	REVISION	06/23/25	TF
ľ	3	REVISION	07/08/25	TF
П				
Γ		-	•	
1				

DRAWN: RAK JOB: T2400870 GR-2

CHECK: JKR

GROUNDING DETAILS

(HS)

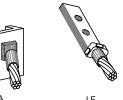






(VS)



SCALE: NONE

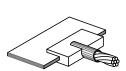


GROUND BAR DETAIL

THE FOLLOWING SYMBOLS SHOWN ARE <u>HARGER</u>
ULTRAWELD EXOTHERMIC CONNECTIONS WITH PART NUMBERS BELOW. THESE CONNECTIONS MAY BE CROSS-REFERENCED WITH CADWELD CONNECTIONS

WHICH ARE SHOWN IN PARENTHESIS




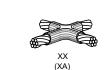

BS (SS)





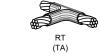



SCALE: NONE

3

HYBRID CABLE GROUNDING KIT

SCALE: NONE

- HYBRID CABLE (O)

TO ANTENNA

-WEATHER

-HYBRID CABLE **GROUNDING KIT**

#2 AWG,

STRANDED COPPER GROUNDING CONDUCTOR

TO GROUND TO PRIMARY CABINET

- 1. CONSTRUCTION TYPE II-B (TABLE 601)
- 2. GROUP U OCCUPANCY (SECTION 312.1 UNOCCUPIED TOWER SITE)

MODIFICATION AND DESIGN DRAWINGS FOR AN EXISTING

PROPOSED CARRIER: T-MOBILE

110' MONOPOLE TOWER

SITE: MO17428-A-SBA / WEST BROADWAY COORDINATES (LATITUDE: 38.953040°, LONGITUDE: -92.357050°)

CONSTRUCTION CLASS

THE CONSTRUCTION PLAN FOR THIS SITE WOULD BE A MINIMUM OF A CLASS IV AND THE CONTRACTOR SHALL MAKE FINAL DETERMINATION

> PLEASE NOTE THIS SET OF DRAWINGS IS FOR INSTALLATION AND ASSEMBLY ONLY. FABRICATION DETAIL DRAWINGS ARE NOT PROVIDED AND MUST BE COMPLETED BY THE STEEL FABRICATOR SELECTED. TES CAN PROVIDE THE FABRICATION DETAIL DRAWINGS FOR AN ADDITIONAL FEE.

SHEET	SHEET TITLE	REV
T-1	TITLE SHEET	1
ВОМ	BILL OF MATERIALS	1
GN-1	GENERAL NOTES	0
A-1	TOWER PROFILE	1
A-1A	ADDITIONAL DETAILS	1
A-2	MONOPOLE SECTION INSTALLATION DETAILS	0
A-3	MONOPOLE SECTION INSTALLATION DETAILS	0

NOTE:

1. THE MODIFICATION DRAWINGS ARE BASED ON THE TES PROJECT NO. 148637, DATED 06/06/2024.

A CONGRUEX® COMPANY

1320 GREENWAY DRIVE, SUITE 600 IRVING, TX 75038 PHONE: (972) 483-0607



8051 CONGRESS AVENUE BOCA RATON, FL 33487 (800)-487-SITE

> TES JOB NO: 148890

CUSTOMER SITE NO: M017428-A-SBA CUSTOMER SITE NAME: WEST BROADWAY

1201 WEST BROADWAY COLUMBIA, MO 65203

STACEY E. HESSELBEIN, PE CIVIL ENGINEERING LICENSE # 201901588 TOWER ENGINEERING SOLUTIONS, LLC PROFESSIONAL ENGINEERING CORPORATION COA # E-2014025012



10/17/2024

DRAWN	N BY: DCR	CHECKE	D BY	: TA/JRL
REV.	DESCRIPTION		BY	DATE
Δ£	RST ISSUE		DCR	09/03/2
<u> </u>	REVISED		DCR	10/17/2
\triangle _				
\triangle				
\triangle_{-}				
SHEET	TITLE:			

TITLE SHEET

This drawing/document is the property of Tower Engineering Solutions, LLC. Information contained herein is considered confidential in nature and is to be used only for the specific site that it was intended for. Reproduction, transmission, publication or disclosure by any method is prohibited except by express written permission from Tower Engineering Solutions, LLC. Without drawing/document remains the property of Tower Engineering Solutions, LLC.

SHEET	NUMBER:	

1 - 1

NTITY	QUANTITY PROVIDED	PART NUMBER	DESCRIPTIONS	LENGTH	SHEET LIST (INSTALLATION)	SHEET LIST (FABRICATE)		WEIGHT (LB)	NOTES
NILD	FROVIDED		MATERIAL & HARDWARE	_	(IIII)		(LBS)	 	
			MATERIAL & HARDWARE						
									
								 -	
								 	
								 	1
\dashv			<u> </u>					 	
				-	-			 	+
					1				+
				+	 				
					1				
_ 1									
]								
									
					-				1
								 	
		2	Following Items are Non-standard Parts						
1	1	MPE-20-15W1	MONOPOLE EXTENSION WELDMENT (PIPE HSS20.000X0.375 X 15'-0") (42 KSI) A500 GR-B (GALVANIZED)	15'-0"	A-2	F-1	1831.41	1831.4	Paint to Match Existin
1	1	FP-20	FLANGE PLATE PL 1 1/2" X 3'-3" DIA A572-50		A-2	F-4	331.2	331.2	Galvanized
24	28		BOLT 1" X 4 3/4" A325	451.00	A-2, A-3		1.8	50.4	(1) HHN & FLW Galvaniz
1 1	1	MPE-20-15W2 CPL-20	MONOPOLE EXTENSION WELDMENT (PIPE HSS20.000X0.375 X 15'-0") (42 KSI) A500 GR-B (GALVANIZED) TOP CAP PLATE PL 3/16" X 2'-2 1/2" DIA A36	15'-0"	A-3 A-3	F-2 F-4	1492.47 30.8	1492.47 30.8	Paint to Match Existin Galvanized
2	4		BOLT 1" X 3 1/2" A325		A-3	r-4 	1.52	6.08	(1) HHN & FLW Galvania
1	~~ 1	C30-086-006	5/8" DIA X 6'-0" COPPER-CLAD LIGHTNING ROD (SABRE OR EQUIV.)		A-1, A-1A				(1) THIN & TEW Galvaille
1	1	T1805KT	TRI-SECTOR CHAIN MOUNT KIT (KENWOOD OR EQUIV.)		A-1A				Galvanized
,	2 🔨	MP-1	2" PST PIPE (2.375" O.D. X 0.154" THICKNESS) X 8'-0" A53, GR-B		A-1A		30.14	90.4	Galvanized
\sim	~~~ <u>~</u> 1	-							
1	1		LANCO RC-300 OR HENRY 287 WHITE ACRYLIC ELASTOMERIC COATING AND SEALER OR EQUIV (GALLON)		A-1A				Provided By Contracto
					-				
\dashv					-				
\rightarrow					+				
-+			<u> </u>						
[<u> </u>
					-				
			ALL ADIAVAY I DAVAY AND DI DAVAY AND DATENTED DOCUMES AND CANDOT DE FARRICATED DE COMPANION DE FARRICA		 				1
			ALL APLXXXX, LPXXXX AND RLPXXXX ARE PATENTED PRODUCTS AND CANNOT BE FABRICATED BY THIRD					1	
	+		PARTIES. THESE PARTS ARE AVAILABLE FROM:		+				+
			METROSITE, LLC. 180 IND PARK BLVD COMMERCE, GA 30529		+				+
			OFFICE: (706) 335-7045		 				
			FAX: (706) 335-7056		<u> </u>				
					1				
			NOTE: ALL MATERIALS, WHICH WEREN'T LISTED IN THIS SHEET, ARE ASSUMED TO BE PROVIDED BY THE CONTRACTOR.					· ·	



A CONGRUEX® COMPANY

1320 GREENWAY DRIVE, SUITE 600 IRVING, TX 75038 PHONE: (972) 483-0607



8051 CONGRESS AVENUE BOCA RATON, FL 33487 (800)-487-SITE

> TES JOB NO: 148890

CUSTOMER SITE NO: M017428-A-SBA CUSTOMER SITE NAME: WEST BROADWAY 1201 WEST BROADWAY

COLUMBIA, MO 65203

STACEY E. HESSELBEIN, PE
CIVIL ENGINEERING LICENSE # 2019015881
TOWER ENGINEERING SOLUTIONS, LLC
PROFESSIOLAL ENGINEERING CORPORATION
COA # E-2014025012

DRAV	VN BY: DCR	CHECKED	BY:	TA/JRL
REV.	DESCRIPTION		BY	DATE
◬	FIRST ISSUE	D	CR_	09/03/2
\triangle	REVISED	D	CR_	10/17/2
\triangle				
\triangle				
$\overline{\triangle}$				

SHEET TITLE:

BILL OF MATERIALS

This drawing/document is the property of Tower Engineering Solutions, LLC. Information contained herein is considered confidential in nature and is to be used only for the specific site that it was intended for. Reproduction, transmission, publication or disclosure by any method is prohibited except by express written permission from Tower Engineering Solutions, LLC. Without exception, the information on this drawing/document remains the property of Tower Engineering Solutions, LLC.

SHEET NUMBER:

REV #: BOM

GENERAL NOTES

- 1. ALL WORK SHALL COMPLY WITH THE ANSI/TIA-222-H, ANSI/ASSP A10.48, AND ANY OTHER GOVERNING BUILDING CODES AND OSHA SAFETY REGULATIONS.
- 2. ALL WORK INDICATED ON THE DRAWINGS SHALL BE PERFORMED BY QUALIFIED CONTRACTORS EXPERIENCED IN TELECOMMUNICATIONS TOWER, POLE AND FOUNDATION CONSTRUCTION.
- THE CONTRACTOR SHALL BE RESPONSIBLE FOR THE DESIGN AND FABRICATION OF ALL MISCELLANEOUS PARTS (SUCH AS SHIMS), TEMPORARY SUPPORTS, AND GUYINGS, ETC., PER ANSI/ASSP A10.48, TO COMPLETE THE ASSEMBLY AS SHOWN IN THE DRAWINGS.
- 4. CONTRACTOR SHALL PROCEED WITH THE INSTALLATION WORK CAREFULLY SO THE WORK WILL NOT DAMAGE ANY EXISTING CABLE, EQUIPMENT OR THE STRUCTURE.
- 5. THE USE OF GAS TORCH OR WELDER, ARE NOT ALLOWED ON ANY TOWER STRUCTURE WITHOUT THE CONSENT OF THE TOWER OWNER
- 6. GENERALLY THE CONTRACTOR IS RESPONSIBLE TO CONDUCT AN ONSITE VISIT SURVEY OF THE JOB SITE AFTER AWARD, AND REPORT ANY ISSUES WITH THE SITE TO **TES** BEFORE PROCEEDING CONSTRUCTION.

FABRICATION

- 1. ALL STEEL SHALL MEET OR EXCEED THE MINIMUM STRENGTH AS SPECIFIED IN THE DRAWINGS. IF YIELD STRENGTH WAS NOT NOTED IN THE DRAWINGS. CONTRACTORS SHALL CONTACT TES FOR DIRECTION.
- 2. ALL FIELD CUT EDGES SHALL BE GROUND SMOOTH. ALL FIELD CUT AND DRILLED SURFACES SHALL BE REPAIRED WITH A MINIMUM OF TWO COATS OF ZINCKOTE GALVANIZING COMPOUND PER ASTM A780 AND MANUFACTURER'S RECOMMENDATIONS.

WELDING

- 1. ALL WELDING SHALL BE PERFORMED BY AWS CERTIFIED WELDERS AND IN ACCORDANCE WITH THE LATEST EDITION OF THE AWS WELDING CODE D1.1. ALL ELECTRODES TO BE LOW HYDROGEN, MATCHING FILLER METAL, PER AWS D1.1, UNO. (E70XX UNLESS NOTED OTHERWISE).
- 2. PRIOR TO FIELD WELDING GALVANIZED MATERIAL, CONTRACTOR SHALL GRIND OFF GALVANIZING APPROX. 0.5" BEYOND THE PROPOSED FIELD WELD SURFACES.
- 3. ALL WELDS SHALL BE INSPECTED VISUALLY. A MINIMUM OF 25% OF WELDS SHALL BE INSPECTED WITH DYE PENETRANT OR MAGNETIC PARTICLE TO MEET THE ACCEPTANCE CRITERIA OF AWS D1.1. 100% OF WELDS SHALL BE INSPECTED IF DEFECTS ARE FOUND.
- 4. WELD INSPECTIONS SHALL BE PERFORMED BY AN AWS CERTIFIED WELD INSPECTOR.
- 5. AFTER INSPECTION, ALL FIELD WELDED SURFACES SHALL BE REPAIRED WITH A MINIMUM OF TWO COATS OF ZINCKOTE GALVANIZING COMPOUND PER ASTM A780 AND MANUFACTURER'S RECOMMENDATIONS.

BOLTED ASSEMBLIES AND TIGHTENING OF CONNECTIONS

- 1. ALL HIGH STRENGTH BOLTS SHALL CONFORM TO THE PROVISIONS OF THE SPECIFICATIONS FOR STRUCTURAL JOINTS USING A325 OR A490 BOLTS AS APPROVED BY THE RCSC.
- 2. FLANGE BOLTS SHALL BE TIGHTENED BY THE AISC "TURN-OF-THE-NUT" METHOD. THE FOLLOWING TABLE SHOULD BE USED FOR THE "TURN-OF-THE-NUT" TIGHTENING.
- 3. SPLICE BOLTS AND ALL OTHER BOLTS IN BEARING TYPE CONNECTIONS SHALL BE TIGHTENED TO A SNUG-TIGHT CONDITION.
- 4. THE SNUG-TIGHT CONDITION IS DEFINED AS THE TIGHTNESS ATTAINED BY EITHER A FEW IMPACTS OF AN IMPACT WRENCH OR THE FULL EFFORT OF AN IRONWORKER WITH AN ORDINARY SPUD WRENCH TO BRING THE CONNECTED PLIES INTO FIRM CONTACT.
- 5. HB HOLLO-BOLT SHALL BE INSTALLED PER ICC ESR-3330 INSTRUCTIONS.

VERIFICATION AND INSPECTION

1. IF APPLICABLE, VERIFICATION INSPECTION TO BE PERFORMED SHALL BE IN ACCORDANCE TO IBC-2018 SECTION 1705.2 FOR STEEL CONSTRUCTION & TABLE 1705.3 FOR CONCRETE CONSTRUCTION.

POST INSTALLED EPOXY INJECTED ANCHOR BOLTS:

- 1. CONCRETE MUST BE A MINIMUM OF 28 DAYS OLD.
- 2. FOLLOW MANUFACTURER'S REQUIREMENTS FOR CURE TIME VS. AMBIENT TEMPERATURE.
- DRILL HOLE TO REQUIRED DIAMETER AND DEPTH. ALL WATER, DIRT, OIL, DEBRIS, GREASE OR DUST MUST BE REMOVED FROM EACH CORE HOLE. FOLLOW MANUFACTURER'S RECOMMENDATION FOR CORRECT TYPE OF CORE BIT. AVOID DAMAGING EXISTING REINFORCING STEEL OR OTHER EMBEDDED ITEMS. NOTIFY TES ENGINEERING IF VOIDS IN THE CONCRETE, REINFORCING STEEL OR OTHER EMBEDDED ITEMS ARE ENCOUNTERED. STOP CORING IMMEDIATELY IF THIS OCCURS.
- 4. A HOLE ROUGHENING DEVICE FROM EITHER HILTI OR ALLFASTENERS SHALL BE USED WITH ALL HOLES. FOLLOW ALL MANUFACTURER'S RECOMMENDED CORING AND INSTALLATION INSTRUCTIONS.
- 5. AFTER CORING AND ROUGHENING, FLUSH EACH HOLE WITH RUNNING WATER TO REMOVE ANY SLURRY OR DEBRIS. REMOVE ALL WATER FROM THE HOLE BY MECHANICAL PUMPING.
- 6. BRUSH EACH HOLE WITH AN APPROPRIATE SIZED NYLON BRUSH AND FLUSH WITH RUNNING WATER A SECOND TIME. REMOVE ALL WATER FROM THE HOLE.
- 7. AFTER THE SECOND WATER FLUSH BRUSH THE HOLE AGAIN WITH THE APPROPRIATE SIZED NYLON BRUSH.
- 8. BLOW EACH HOLE WITH COMPRESSED AIR TWO TIMES MINIMUM.
- 9. CONFIRM THAT EACH HOLE IS PROPERLY ROUGHED AND DRY.
- 10. NO EPOXY INJECTION SHALL TAKE PLACE IN RAINY CONDITIONS.
- 11. EPOXY SHOULD BE VISIBLE AT THE TOP OF THE CORE HOLE AFTER INSTALLATION.
- 12. CONTRACTOR TO SUPPLY ONE PHOTO OF EACH ROUGHED AND CLEANED HOLE IN CLOSEOUT PHOTO PACKAGE.

TABLE 8.2 NUT ROTATION FROM SNUG-TIGHT CONDITION FOR TURN-OF-NUT PRETENSIONING a,b

	DISPOSITION OF OUTER FACE OF BOLTED PARTS			
BOLT LENGTH ^C	BOTH FACES NORMAL TO BOLT AXIS	ONE FACE NORMAL TO BOLT AXIS, OTHER SLOPED NOT MORE THAN 1:20 ^d	BOTH FACES SLOPED NOT MORE THAN 1:20 FROM NORMAL TO BOLT AXIS ^d	
NOT MORE THAN 4d _b	1/3 TURN	1/2 TURN	2/3 TURN	
MORE THAN 4d _b BUT NOT MORE THAN 8d _b	1/2 TURN	2/3 TURN	5/6 TURN	
MORE THAN 8d _b BUT NOT MORE THAN 12d _b	2/3 TURN	5/6 TURN	1 TURN	

O NUT ROTATION IS RELATIVE TO BOLT REGARDLESS OF THE ELEMENT (NUT OR BOLT) BEING TURNED. FOR REQUIRED NUT ROTATIONS OF 1/2 TURN AND LESS, THE TOLERANCE IS PLUS OR MINUS 30 DEGREES; FOR REQUIRED NUT ROTATIONS OF 2/3 TURN AND MORE, THE TOLERANCE IS PLUS OR MINUS 45 DEGREES.

SPECIFICATION FOR STRUCTURAL JOINTS USING ASTM A325 OR A490 BOLTS, JUNE 30, 2004 RESEARCH COUNCIL ON STRUCTURAL CONNECTIONS

INSTALLATION TORQUE REQUIRED FOR HOLLO BOLTS AND AJAX BOLTS:

- 1. HB12 HOLLO BOLT: 59 FT-LBS
- 2. HB16 HOLLO BOLT: 140 FT-LBS
- 3. HB20 HOLLO BOLT: 221 FT-LBS
- 4. M20 AJAX BOLT: 280 FT-LBS.

FIELD HOT WORK PLAN NOTES:

FOLLOWING GUIDELINES SHALL BE COMPLIED WITH:

- CONTRACTOR'S RESPONSIBILITY TO COMPLETE A HOT WORK PLAN IF AWARDED PER CUSTOMER SPECIFICATIONS GUIDELINES FOR WELDING, CUTTING & SPARK PRODUCING WORK.
- 2. HAVE A FIRE PLAN APPROVED BY THE CUSTOMER AND THEIR SAFETY MANAGEMENT DEPT.
- CONTRACTOR MUST OBTAIN THE CONTACT INFO OF THE LOCAL FIRE DEPARTMENT AND THE 911
 ADDRESS OF THE TOWER SITE BEFORE CONSTRUCTION.
- 4. CONTRACTOR SHALL MAKE SURE THAT CELL PHONE COVERAGE IS AVAILABLE IN THE TOWER SITE. IF CELL COVERAGE IS NOT AVAILABLE, AN IMMEDIATE AVAILABLE MEANS OF DIRECT COMMUNICATION WITH THE FIRE DEPARTMENT SHALL BE DETERMINED PRIOR TO CONSTRUCTION START.
- 5. ALL CONSTRUCTION SHALL BE PERFORMED UNDER WIND SPEED LESS THAN 10 MPH ON THE GROUND LEVEL. IF WIND SPEED INCREASE, CONTRACTOR MUST DETERMINE IF CONSTRUCTION SHALL BE DISCONTINUED.
- 6. FIRE SUPPRESSION EQUIPMENT MUST BE MADE AVAILABLE ON SITE AND READY TO USE.
- 7. CONTRACTOR SHALL ASSIGN A FIRE WATCHER TO PERFORM FIRE-FIGHTING DUTIES.
- 8. ALL WELDERS SHALL BE AWS OR STATE CERTIFIED. THEY MUST ALSO BE EXPERIENCED IN WELDING ON GALVANIZED MATERIALS.
- 9. IF IT IS POSSIBLE, ALL EXISTING COAX NEAR WELDING AREA SHALL BE TEMPORARILY MOVED AWAY FROM THE WELDING AREA BEFORE WELDING THE PLATES.
- 10. PLEASE REPORT ANY FIELD ISSUE TO TES @ 972-483-0607.

XTES

A CONGRUEX® COMPANY

1320 GREENWAY DRIVE, SUITE 600 IRVING, TX 75038 PHONE: (972) 483-0607



8051 CONGRESS AVENUE BOCA RATON, FL 33487 (800)-487-SITE

TES JOB NO: 148890

CUSTOMER SITE NO:
MO17428-A-SBA
CUSTOMER SITE NAME:
WEST BROADWAY

1201 WEST BROADWAY COLUMBIA, MO 65203 STACEY E. HESSELBEIN, PE

STACET E. HESSELBEIN, PE.
CIVIL ENGINEERING LICENSE # 2019015881
TOWER ENGINEERING SOLUTIONS, LLC
PROFESSIONAL ENGINEERING CORPORATION
COA # E-2014025012

DRAW	/N BY: DCR	CHECKED BY	: TA/JRL
REV.	DESCRIPTION	BY	DATE
	FIRST ISSUE	DCR	09/03/2
\wedge			
$\overline{\wedge}$			
$\overline{\wedge}$			
$\overline{\wedge}$			

GENERAL NOTES

This drawing/document is the property of Tower Engineering Solutions, LLC. Information contained herein is considered confidential in nature and is to be used only for the specific site that it was intended for. Reproduction, transmission, publication or disclosure by any method is prohibited except by express written permission from Tower Engineering Solutions, LLC. Without exception, the information on this drawing/document remains the property of Tower Engineering Solutions, LLC.

SHEET NUMBER:

SHEET TITLE:

3N-1

0

REV #:

 $^{^{\}mathrm{b}}$ applicable only to joints in which all material within the GRIP is steel.

WHEN THE BOLT LENGTH EXCEEDS 12d_b, THE REQUIRED NUT ROTATION SHALL BE DETERMINED BY ACTUAL TESTING IN A SUITABLE TENSION CALIBRATOR THAT SIMULATES THE CONDITIONS OF SOLIDLY FITTING STEEL.

d BEVELED WASHER NOT USED.

NOTES:


- TEMPORARILY RELOCATE ANY EXISTING COAX ATTACHED TO THE MONOPOLE AND ANY OTHER MEMBERS WHERE OBSTRUCTION WITH THE PROPOSED MODIFICATION MAY OCCUR.
- 2. TEMPORARY RELOCATION OF EXISTING EQUIPMENT AROUND THE FOUNDATION MAY BE REQUIRED DURING CONSTRUCTION.

SCOPE OF WORK

- A. TEMPORARILY RELOCATE (3) EXISTING COMMSCOPE JAH4-65C-R4 PANEL ANTENNAS AT ±106'-0" ELEV. AND ASSOCIATED EQUIPMENT USING PROVIDED 3-SECTOR CHAIN MOUNT AND MOUNT PIPES (T1805KT & MP-1) BELOW NEW FLANGE AT ±60'-0" ELEV. (FINAL LOCATION TO BE DETERMINED BY AT&T)
 - SB. B. RE-ROUTE EXISTING (12) 1 5/8" & (4) RET COAX LINES FROM INSIDE THE POLE & INSTALL TEMPORARILY TO THE OUTSIDE OF THE POLE. SEE DETAIL 1 ON SHEET A-1A FOR AZIMUTHS. CONTRACTOR TO COORDINATE ALL ANTENNA RELOCATION WORK WITH AT&T.
- PREMOVE EXISTING (3) ± 30 " 0.D. X ± 10 '-0" CANISTER SHROUDS, TRANSITION CONE AND SPINE FROM ± 80 '-0" TO ± 110 '-0" ELEV.
- > INSTALL NEW HSS20.000X0.375 X 15'-0" A500 GR-B (42 KSI) POLE SECTION FROM \$\frac{\pmathbb{\pmathb{\pmathbb{\pmathbb{\pmathbb{\pmathbb{\pmathbb{\pmathbb{\pmathbb{
- NOTE: NEW MONOPOLE SECTION COLOR TO MATCH EXISTING TOWER COLOR.
- - CONTRACTOR TO MOVE EXISTING AT&T ANTENNAS AND ASSOCIATED EQUIPMENT BACK TO THE ORIGINAL ELEVATION AT ±106'-0" ELEV. CONTRACTOR TO COORDINATE ALL ANTENNA RELOCATION WORK WITH AT&T.
- 6 INSTALL NEW LIGHTNING ROD AT TOP OF THE NEW SECTION AND FIELD CUT IT DOWN IF REQUIRED TO MEET FAA APPROVAL. SEE DETAIL 2 ON SHEET A-1A.
- 7 APPLY FOUNDATION COATING, SEE NOTES ON SHEET A-1A.
- THE CONTRACTOR SHALL BE RESPONSIBLE FOR THE CLEAN-UP, REMOVAL AND DISPOSAL OF EXCESS MATERIALS USED AND REMOVED FROM THE STRUCTURE AT THE COMPLETION OF THE PROJECT.

INSTALLATION NOTE:

VERTICAL ALIGNMENT IS REQUIRED FOR ALL THE EXTENSION PROJECTS, TOWERS OR POLES

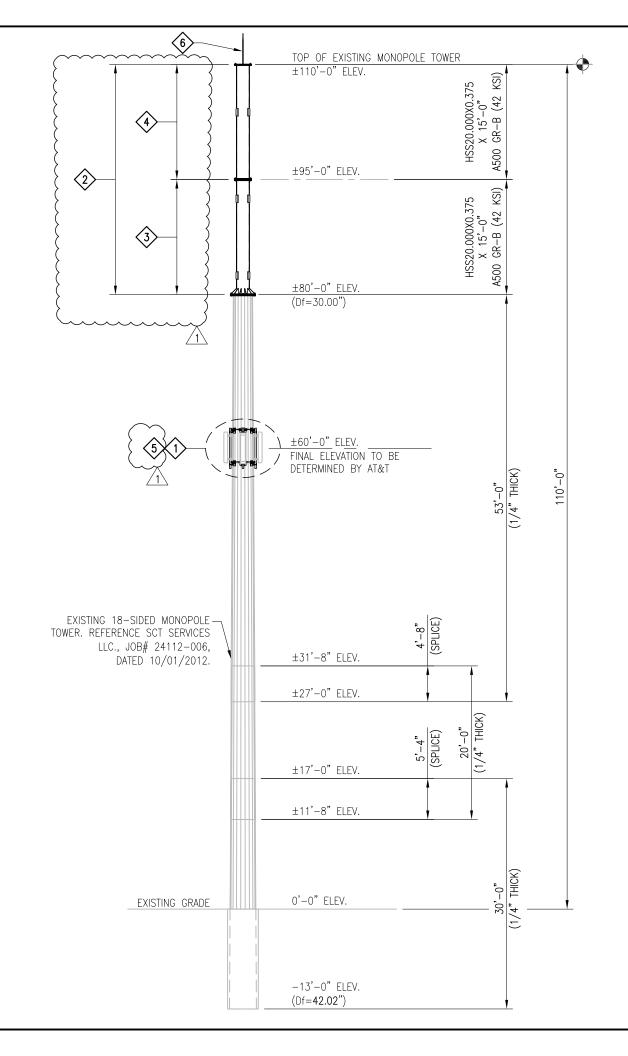



A CONGRUEX® COMPANY

1320 GREENWAY DRIVE, SUITE 600 IRVING, TX 75038 PHONE: (972) 483-0607



8051 CONGRESS AVENUE BOCA RATON, FL 33487 (800)-487-SITE

TES JOB NO: 148890

CUSTOMER SITE NO:
MO17428-A-SBA
CUSTOMER SITE NAME:
WEST BROADWAY

1201 WEST BROADWAY COLUMBIA, MO 65203

CIVIL ENGINEERING LICENSE # 2019015881
TOWER ENGINEERING SOLUTIONS, LLC
PROFESSIONAL ENGINEERING CORPORATION
COA # E-2014025012

DRAWN BY: DCR	CHECKED BY: TA/JRL
REV. DESCRIPTION FIRST ISSUE	BY DATE DCR 09/03/2
REVISED A A	DCR 10/17/2

SHEET TITLE:

TOWER PROFILE

This drawing/document is the property of Tower Engineering Solutions, LLC. Information contained herein is considered confidential in nature and is to be used only for the specific site that it was intended for. Reproduction, transmission, publication or disclosure by any method is prohibited except by express written permission from Tower Engineering Solutions, LLC. Without exception, the information on this drawing/document remains the property of Tower Engineering Solutions, LLC.

SHEET NUMBER:

A-1

REV #:

opyright 2024 Tower Engineering Solutions 11.C.





LIGHTNING ROD AS REQUIRED TO MEET FAA HEIGHT APPROVAL (116' A.G.L.)

LIGHTNING ROD W/ NON-FERROUS HARDWARE. INSTALL NEW LIGHTNING ROD TO THE TOP OF THE POLE.

> NEW EXTENSION-DETAIL 2


<u>PHOTO 1</u>

FOUNDATION COATING NOTES:

- 1. THE COATING MATERIALS SHALL BE LANCO WHITE ACRYLIC ELASTOMERIC COATING AND SEALER, OR HYDRO ARMOR COATING.
- 2. THE COATING CAN BE PLACED AT LEAST (2) DAYS AFTER THE PLACEMENT OF THE CONCRETE FOR FOUNDATION REINFORCEMENT, AND MINIMUM (4) DAYS FOR NEW FOUNDATION CONSTRUCTION.
- 3. THE CONCRETE SURFACE SHALL BE CLEAN AND DRY PRIOR TO THE APPLICATION OF THE COATING.
- 4. THE COATING SHALL BE APPLIED TO ALL THE SURFACES OF THE CONCRETE ABOVE THE GROUND AND 6"BELOW THE GRADE SURFACE IF APPLICABLE.
- 5. MINIMUM 30 MILS COATING IS REQUIRED.

CONTRACTOR TO FIELD CUT -

5/8"ø X 6'-0" COPPER CLAD-(SABRE PART# C30-086-006 OR EQUIVALENT).

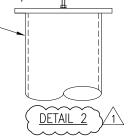

A CONGRUEX® COMPANY

1320 GREENWAY DRIVE, SUITE 600 IRVING, TX 75038 PHONE: (972) 483-0607



8051 CONGRESS AVENUE BOCA RATON, FL 33487 (800)-487-SITE

> TES JOB NO: 148890

CUSTOMER SITE NO: M017428-A-SBA CUSTOMER SITE NAME: WEST BROADWAY

1201 WEST BROADWAY COLUMBIA, MO 65203

STACEY E. HESSELBEIN, PE
CIVIL ENGINEERING LICENSE # 2019015881
TOWER ENGINEERING SOLUTIONS, LLC
PROFESSIONAL ENGINEERING CORPORATION
COA # E-2014025012

DRAWN	BY: DCR	CHECKED E	3Y:	TA/JRL
REV.	DESCRIPTION	B,	′	DATE
<u>∕</u> Ô\ <u>FIRS</u>	ST ISSUE	DC	<u>R</u>	09/03/24
1 RE	VISED	DC	R_	10/17/24
\triangle _			_	
\triangle _			_	
\triangle _			_	
I				

ADDITIONAL DETAILS


This drawing/document is the property of Tower Engineering Solutions, LLC. Information contained herein is considered confidential in nature and is to be used only for the specific site that it was intended for. Reproduction, transmission, publication or disclosure by any method is prohibited except by express written permission from Tower Engineering Solutions, LLC. Without exception, the information on this drawing/document remains the property of Tower Engineering Solutions, LLC.


SHEET NUMBER:


SHEET TITLE:

REV #:

A-1A

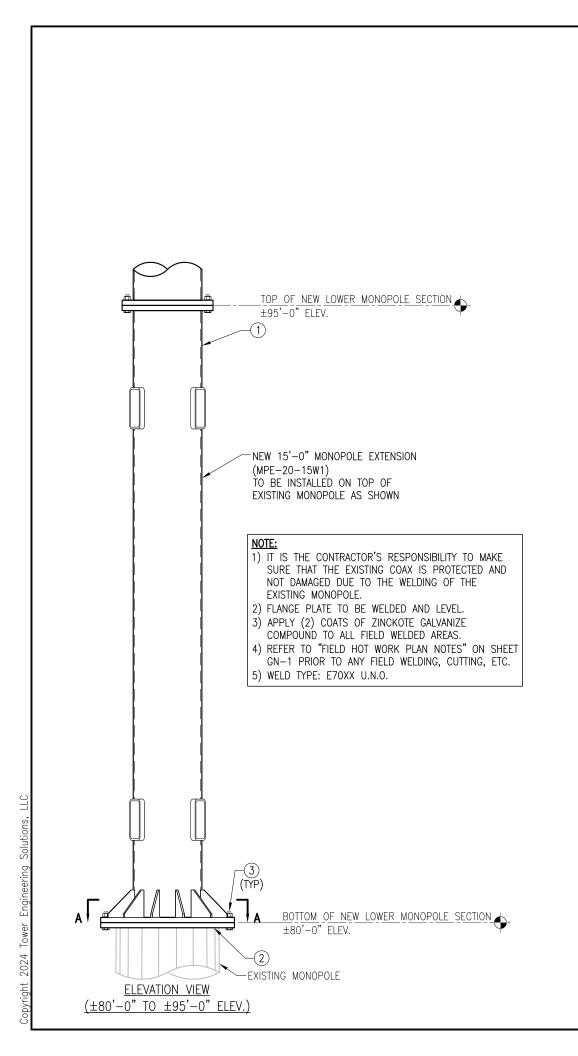

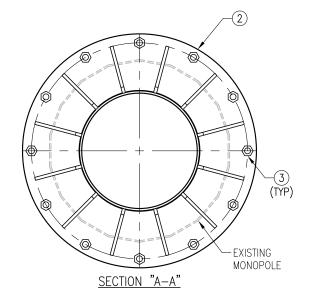


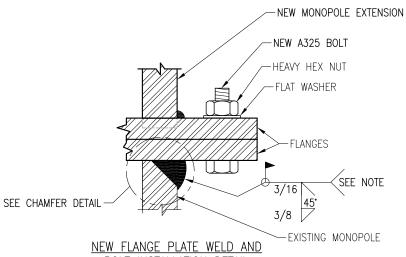

BOLT INSTALLATION DETAIL

TIGHTEN FLANGE BOLTS PER NOTES ON SHEET GN-1. TABLE 8.2.

FIELD NOTE: DO NOT USE A LOCKWASHER WITH THIS CONNECTION.

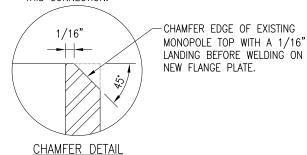

12 BOLT 1" X 4 3/4" A325 W/ NUT-FW EA. ___ FLANGE PLATE PL 1 1/2" X 3'-3" DIA A572-50 FP-20 MPE-20-15W1 MONOPOLE EXTENSION WELDMENT (PIPE HSS20.000X0.375 X 15'-0") (42 KSI) A500 GR-B ITEM QTY. PART NO. DESCRIPTION NO.



A CONGRUEX® COMPANY

1320 GREENWAY DRIVE, SUITE 600 IRVING, TX 75038 PHONE: (972) 483-0607



8051 CONGRESS AVENUE BOCA RATON, FL 33487 (800)-487-SITE

> TES JOB NO: 148890

CUSTOMER SITE NO: M017428-A-SBA CUSTOMER SITE NAME: WEST BROADWAY 1201 WEST BROADWAY COLUMBIA, MO 65203

STACEY E. HESSELBEIN, PE
CIVIL ENGINEERING LICENSE # 2019015881
TOWER ENGINEERING SOLUTIONS, LLC
PROFESSIONAL ENGINEERING CORPORATION
COA # E-2014025012

DRAWN BY: DCR	CHECKED BY: TA/JRL		
REV. DESCRIPTION	BY DATE		
<u> </u>	DCR 09/03/24		
\land			
$\overline{\wedge}$			
$\overline{\wedge}$			
$\overline{\wedge}$			


SHEET TITLE:


MONOPOLE SECTION INSTALLATION DETAILS

his drawing/document is the property of Tower Engineering Solutions, LLC. Information contained herein is considered confidential ir nature and is to be used only for the specific site that it was intended for. Reproduction, transmission, publication or disclosure by any method is prohibited except by express written permission from Tower Engineering Solutions, LLC. Without exception, the information on this drawing/document remains the property of Tower Engineering Solutions, LLC.


SHEET NUMBER:


REV #:

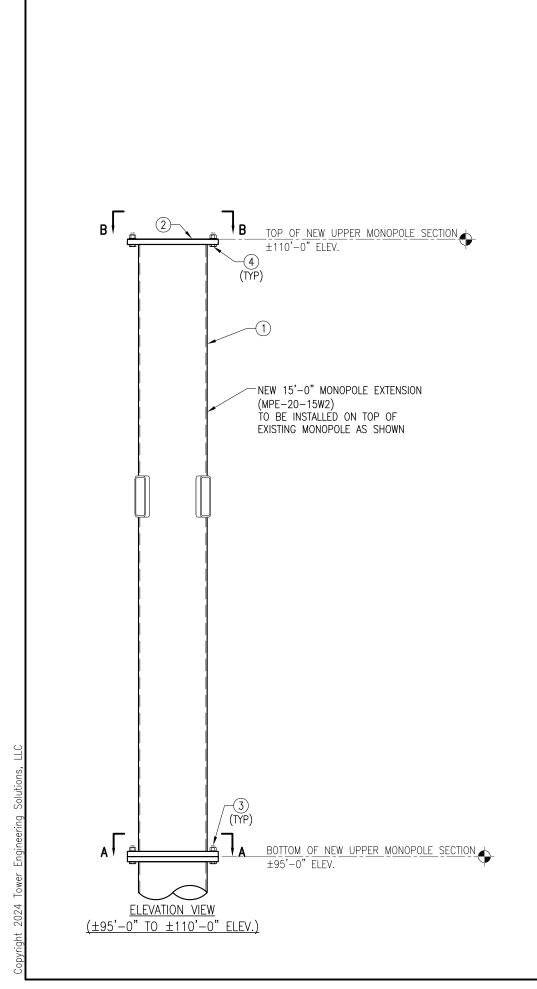

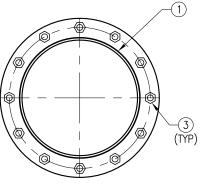



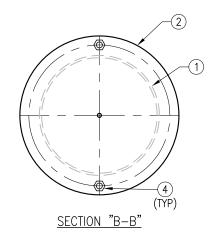

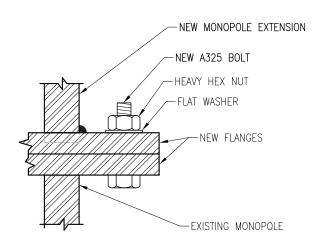

NEW FLANGE PLATE WELD AND BOLT INSTALLATION DETAIL

TIGHTEN FLANGE BOLTS PER NOTES ON SHEET GN-1. TABLE 8.2.

FIELD NOTE:
DO NOT USE A LOCKWASHER WITH THIS CONNECTION.

BOLT 1" X 3 1/2" A325 W/ NUT-FW EA. 3 12 ---BOLT 1" X 4 3/4" A325 W/ NUT-FW EA. TOP CAP PLATE PL 3/16" X 2'-2 1/2" DIA A36 CPL-20 MPE-20-15W2 MONOPOLE EXTENSION WELDMENT (PIPE HSS20.000X0.375 X 15'-0") (42 KSI) A500 GR-B ITEM NO. QTY. PART NO. DESCRIPTION



A CONGRUEX® COMPANY

1320 GREENWAY DRIVE, SUITE 600 IRVING, TX 75038 PHONE: (972) 483-0607



8051 CONGRESS AVENUE BOCA RATON, FL 33487 (800)-487-SITE

> TES JOB NO: 148890

CUSTOMER SITE NO: M017428-A-SBA CUSTOMER SITE NAME: WEST BROADWAY 1201 WEST BROADWAY

COLUMBIA, MO 65203

STACEY E. HESSELBEIN, PE
CIVIL ENGINEERING LICENSE # 2019015881
TOWER ENGINEERING SOLUTIONS, LLC
PROFESSIONAL ENGINEERING CORPORATION
COA # E-2014025012

DRAWN BY: DCR		CHECKED BY: TA/JRL		
REV.	DESCRIPTION	BY	,	DATE
<u> </u>	ST ISSUE	DC	R_	09/03/24
\wedge				
$ \overline{\wedge} $				
$\overline{\wedge}$				
			_	
SHEET	TITLE:			

MONOPOLE SECTION INSTALLATION DETAILS

This drawing/document is the property of Tower Engineering Solutions, LLC. Information contained herein is considered confidential in nature and is to be used only for the specific site that it was intended for. Reproduction, transmission, publication or disclosure by any method is prohibited except by express written permission from Tower Engineering Solutions, LLC. Without exception, the information on this drawing/document remains the property of Tower Engineering Solutions, LLC.

SHEET NUMBER:

A-3

REV #:

- 1. CONSTRUCTION TYPE II-B (TABLE 601)
- 2. GROUP U OCCUPANCY (SECTION 312.1 UNOCCUPIED TOWER SITE)

MODIFICATION AND DESIGN DRAWINGS FOR AN EXISTING 110' MONOPOLE TOWER

PROPOSED CARRIER: T-MOBILE

SITE: MO17428-A-SBA / WEST BROADWAY COORDINATES (LATITUDE: 38.953040°, LONGITUDE: -92.357050°)

CONSTRUCTION CLASS

THE CONSTRUCTION PLAN FOR THIS SITE WOULD BE A MINIMUM OF A CLASS IV AND THE CONTRACTOR SHALL MAKE FINAL DETERMINATION

> PLEASE NOTE THIS SET OF DRAWINGS IS FOR INSTALLATION AND ASSEMBLY ONLY. FABRICATION DETAIL DRAWINGS ARE NOT PROVIDED AND MUST BE COMPLETED BY THE STEEL FABRICATOR SELECTED. TES CAN PROVIDE THE FABRICATION DETAIL DRAWINGS FOR AN ADDITIONAL FEE.

SHEET	SHEET TITLE	REV
T-1	TITLE SHEET	1
ВОМ	BILL OF MATERIALS	1
GN-1	GENERAL NOTES	0
A-1	TOWER PROFILE	1
A-1A	ADDITIONAL DETAILS	1
A-2	MONOPOLE SECTION INSTALLATION DETAILS	0
A-3	MONOPOLE SECTION INSTALLATION DETAILS	0

NOTE:

A CONGRUEX® COMPANY

1320 GREENWAY DRIVE, SUITE 600 IRVING, TX 75038 PHONE: (972) 483-0607



8051 CONGRESS AVENUE BOCA RATON, FL 33487 (800)-487-SITE

> TES JOB NO: 148890

CUSTOMER SITE NO: M017428-A-SBA CUSTOMER SITE NAME: WEST BROADWAY

1201 WEST BROADWAY COLUMBIA, MO 65203

CIVIL ENGINEERING LICENSE # 2019015881 TOWER ENGINEERING SOLUTIONS, LLC
PROFESSIONAL ENGINEERING CORPORATION COA # E-2014025012



10/17/2024

DRAWN BY: DCR CHECKED BY: TA/JRL BY DATE **∫** FIRST ISSUE DCR 09/03/24 DCR 10/17/24

TITLE SHEET

This drawing/document is the property of Tower Engineering Solutions, LLC. Information contained herein is considered confidential in nature and is to be used only for the specific site that it was intended for. Reproduction, transmission, publication or disclosure by any method is prohibited except by express written permission from Tower Engineering Solutions, LLC. Without drawing/document remains the property of Tower Engineering Solutions, LLC.

HEET	NUMBER:	

1 - 1

1. THE MODIFICATION DRAWINGS ARE BASED ON THE TES PROJECT NO. 148637, DATED 06/06/2024.

NTITY	QUANTITY PROVIDED	PART NUMBER	DESCRIPTIONS	LENGTH	SHEET LIST (INSTALLATION)	SHEET LIST (FABRICATE)		WEIGHT (LB)	NOTES
NILD	FROVIDED		MATERIAL & HARDWARE	_	(IIII)		(LBS)		
			MATERIAL & HARDWARE						
\dashv			<u> </u>						
				-	-				
+					1				
\rightarrow				+	 				
_ †									
					ļ				
				-	-				
					-				
		2	Following Items are Non-standard Parts						
1	1	MPE-20-15W1	MONOPOLE EXTENSION WELDMENT (PIPE HSS20.000X0.375 X 15'-0") (42 KSI) A500 GR-B (GALVANIZED)	15'-0"	A-2	F-1	1831.41	1831.4	Paint to Match Existin
1	1	FP-20	FLANGE PLATE PL 1 1/2" X 3'-3" DIA A572-50		A-2	F-4	331.2	331.2	Galvanized
24	28		BOLT 1" X 4 3/4" A325	451.00	A-2, A-3		1.8	50.4	(1) HHN & FLW Galvaniz
1	1 1	MPE-20-15W2 CPL-20	MONOPOLE EXTENSION WELDMENT (PIPE HSS20.000X0.375 X 15'-0") (42 KSI) A500 GR-B (GALVANIZED) TOP CAP PLATE PL 3/16" X 2'-2 1/2" DIA A36	15'-0"	A-3 A-3	F-2 F-4	1492.47 30.8	1492.47 30.8	Paint to Match Existin Galvanized
2	4		BOLT 1" X 3 1/2" A325		A-3	Γ-4 	1.52	6.08	(1) HHN & FLW Galvania
1	~ 1	C30-086-006	5/8" DIA X 6'-0" COPPER-CLAD LIGHTNING ROD (SABRE OR EQUIV.)		A-1, A-1A				(1) THINK & TEVV GAIVAINIZ
1	1	T1805KT	TRI-SECTOR CHAIN MOUNT KIT (KENWOOD OR EQUIV.)		A-1A				Galvanized
,	2 🔨	MP-1	2" PST PIPE (2.375" O.D. X 0.154" THICKNESS) X 8'-0" A53, GR-B		A-1A		30.14	90.4	Galvanized
\sim	~~~~/1\	-							
1	1		LANCO RC-300 OR HENRY 287 WHITE ACRYLIC ELASTOMERIC COATING AND SEALER OR EQUIV (GALLON)		A-1A				Provided By Contracto
					-				
\rightarrow					-				
\rightarrow	-				+				
+			<u> </u>						
				_	-				
\rightarrow			ALL ADIAVAY I DAVAY AND DI DAVAY AND DATENTED DOCUME AND CANDOT DE FARRICATED DE COMPANION DE COMPANION DE FARRICATED DE COMPANION DE COMPANION DE FARRICATED DE COMPANION DE COMPANION DE FARRICATED DE COMPANION DE FARRICATED DE COMPANION		 				
- 1			ALL APLXXXX, LPXXXX AND RLPXXXX ARE PATENTED PRODUCTS AND CANNOT BE FABRICATED BY THIRD						
\dashv	+		PARTIES. THESE PARTS ARE AVAILABLE FROM:		+				
+			METROSITE, LLC. 180 IND PARK BLVD COMMERCE, GA 30529		+				
\rightarrow			OFFICE: (706) 335-7045		 				
			FAX: (706) 335-7056		<u> </u>				
- 1					1				
			NOTE: ALL MATERIALS, WHICH WEREN'T LISTED IN THIS SHEET, ARE ASSUMED TO BE PROVIDED BY THE CONTRACTOR.						



A CONGRUEX® COMPANY

1320 GREENWAY DRIVE, SUITE 600 IRVING, TX 75038 PHONE: (972) 483-0607



8051 CONGRESS AVENUE BOCA RATON, FL 33487 (800)-487-SITE

> TES JOB NO: 148890

CUSTOMER SITE NO: M017428-A-SBA CUSTOMER SITE NAME: WEST BROADWAY 1201 WEST BROADWAY

COLUMBIA, MO 65203

STACEY E. HESSELBEIN, PE
CIVIL ENGINEERING LICENSE # 2019015881
TOWER ENGINEERING SOLUTIONS, LLC
PROFESSIOLAL ENGINEERING CORPORATION
COA # E-2014025012

DRAV	VN BY: DCR	CHECKED	BY:	TA/JRL
REV.	DESCRIPTION		BY	DATE
◬	FIRST ISSUE	<u>D</u>	CR (09/03/2
\triangle	REVISED	D	CR :	10/17/2
\triangle			_	
\triangle				
$\overline{\triangle}$				

SHEET TITLE:

BILL OF MATERIALS

This drawing/document is the property of Tower Engineering Solutions, LLC. Information contained herein is considered confidential in nature and is to be used only for the specific site that it was intended for. Reproduction, transmission, publication or disclosure by any method is prohibited except by express written permission from Tower Engineering Solutions, LLC. Without exception, the information on this drawing/document remains the property of Tower Engineering Solutions, LLC.

SHEET NUMBER:

REV #: BOM

GENERAL NOTES

- 1. ALL WORK SHALL COMPLY WITH THE ANSI/TIA-222-H, ANSI/ASSP A10.48, AND ANY OTHER GOVERNING BUILDING CODES AND OSHA SAFETY REGULATIONS.
- 2. ALL WORK INDICATED ON THE DRAWINGS SHALL BE PERFORMED BY QUALIFIED CONTRACTORS EXPERIENCED IN TELECOMMUNICATIONS TOWER, POLE AND FOUNDATION CONSTRUCTION.
- THE CONTRACTOR SHALL BE RESPONSIBLE FOR THE DESIGN AND FABRICATION OF ALL MISCELLANEOUS PARTS (SUCH AS SHIMS), TEMPORARY SUPPORTS, AND GUYINGS, ETC., PER ANSI/ASSP A10.48, TO COMPLETE THE ASSEMBLY AS SHOWN IN THE DRAWINGS.
- 4. CONTRACTOR SHALL PROCEED WITH THE INSTALLATION WORK CAREFULLY SO THE WORK WILL NOT DAMAGE ANY EXISTING CABLE, EQUIPMENT OR THE STRUCTURE.
- 5. THE USE OF GAS TORCH OR WELDER, ARE NOT ALLOWED ON ANY TOWER STRUCTURE WITHOUT THE CONSENT OF THE TOWER OWNER
- 6. GENERALLY THE CONTRACTOR IS RESPONSIBLE TO CONDUCT AN ONSITE VISIT SURVEY OF THE JOB SITE AFTER AWARD, AND REPORT ANY ISSUES WITH THE SITE TO **TES** BEFORE PROCEEDING CONSTRUCTION.

FABRICATION

- 1. ALL STEEL SHALL MEET OR EXCEED THE MINIMUM STRENGTH AS SPECIFIED IN THE DRAWINGS. IF YIELD STRENGTH WAS NOT NOTED IN THE DRAWINGS. CONTRACTORS SHALL CONTACT TES FOR DIRECTION.
- 2. ALL FIELD CUT EDGES SHALL BE GROUND SMOOTH. ALL FIELD CUT AND DRILLED SURFACES SHALL BE REPAIRED WITH A MINIMUM OF TWO COATS OF ZINCKOTE GALVANIZING COMPOUND PER ASTM A780 AND MANUFACTURER'S RECOMMENDATIONS.

WELDING

- 1. ALL WELDING SHALL BE PERFORMED BY AWS CERTIFIED WELDERS AND IN ACCORDANCE WITH THE LATEST EDITION OF THE AWS WELDING CODE D1.1. ALL ELECTRODES TO BE LOW HYDROGEN, MATCHING FILLER METAL, PER AWS D1.1, UNO. (E70XX UNLESS NOTED OTHERWISE).
- 2. PRIOR TO FIELD WELDING GALVANIZED MATERIAL, CONTRACTOR SHALL GRIND OFF GALVANIZING APPROX. 0.5" BEYOND THE PROPOSED FIELD WELD SURFACES.
- 3. ALL WELDS SHALL BE INSPECTED VISUALLY. A MINIMUM OF 25% OF WELDS SHALL BE INSPECTED WITH DYE PENETRANT OR MAGNETIC PARTICLE TO MEET THE ACCEPTANCE CRITERIA OF AWS D1.1. 100% OF WELDS SHALL BE INSPECTED IF DEFECTS ARE FOUND.
- 4. WELD INSPECTIONS SHALL BE PERFORMED BY AN AWS CERTIFIED WELD INSPECTOR.
- 5. AFTER INSPECTION, ALL FIELD WELDED SURFACES SHALL BE REPAIRED WITH A MINIMUM OF TWO COATS OF ZINCKOTE GALVANIZING COMPOUND PER ASTM A780 AND MANUFACTURER'S RECOMMENDATIONS.

BOLTED ASSEMBLIES AND TIGHTENING OF CONNECTIONS

- 1. ALL HIGH STRENGTH BOLTS SHALL CONFORM TO THE PROVISIONS OF THE SPECIFICATIONS FOR STRUCTURAL JOINTS USING A325 OR A490 BOLTS AS APPROVED BY THE RCSC.
- 2. FLANGE BOLTS SHALL BE TIGHTENED BY THE AISC "TURN-OF-THE-NUT" METHOD. THE FOLLOWING TABLE SHOULD BE USED FOR THE "TURN-OF-THE-NUT" TIGHTENING.
- 3. SPLICE BOLTS AND ALL OTHER BOLTS IN BEARING TYPE CONNECTIONS SHALL BE TIGHTENED TO A SNUG-TIGHT CONDITION.
- 4. THE SNUG-TIGHT CONDITION IS DEFINED AS THE TIGHTNESS ATTAINED BY EITHER A FEW IMPACTS OF AN IMPACT WRENCH OR THE FULL EFFORT OF AN IRONWORKER WITH AN ORDINARY SPUD WRENCH TO BRING THE CONNECTED PLIES INTO FIRM CONTACT.
- 5. HB HOLLO-BOLT SHALL BE INSTALLED PER ICC ESR-3330 INSTRUCTIONS.

VERIFICATION AND INSPECTION

1. IF APPLICABLE, VERIFICATION INSPECTION TO BE PERFORMED SHALL BE IN ACCORDANCE TO IBC-2018 SECTION 1705.2 FOR STEEL CONSTRUCTION & TABLE 1705.3 FOR CONCRETE CONSTRUCTION.

POST INSTALLED EPOXY INJECTED ANCHOR BOLTS:

- 1. CONCRETE MUST BE A MINIMUM OF 28 DAYS OLD.
- 2. FOLLOW MANUFACTURER'S REQUIREMENTS FOR CURE TIME VS. AMBIENT TEMPERATURE.
- DRILL HOLE TO REQUIRED DIAMETER AND DEPTH. ALL WATER, DIRT, OIL, DEBRIS, GREASE OR DUST MUST BE REMOVED FROM EACH CORE HOLE. FOLLOW MANUFACTURER'S RECOMMENDATION FOR CORRECT TYPE OF CORE BIT. AVOID DAMAGING EXISTING REINFORCING STEEL OR OTHER EMBEDDED ITEMS. NOTIFY TES ENGINEERING IF VOIDS IN THE CONCRETE, REINFORCING STEEL OR OTHER EMBEDDED ITEMS ARE ENCOUNTERED. STOP CORING IMMEDIATELY IF THIS OCCURS.
- 4. A HOLE ROUGHENING DEVICE FROM EITHER HILTI OR ALLFASTENERS SHALL BE USED WITH ALL HOLES. FOLLOW ALL MANUFACTURER'S RECOMMENDED CORING AND INSTALLATION INSTRUCTIONS.
- 5. AFTER CORING AND ROUGHENING, FLUSH EACH HOLE WITH RUNNING WATER TO REMOVE ANY SLURRY OR DEBRIS. REMOVE ALL WATER FROM THE HOLE BY MECHANICAL PUMPING.
- 6. BRUSH EACH HOLE WITH AN APPROPRIATE SIZED NYLON BRUSH AND FLUSH WITH RUNNING WATER A SECOND TIME. REMOVE ALL WATER FROM THE HOLE.
- 7. AFTER THE SECOND WATER FLUSH BRUSH THE HOLE AGAIN WITH THE APPROPRIATE SIZED NYLON BRUSH.
- 8. BLOW EACH HOLE WITH COMPRESSED AIR TWO TIMES MINIMUM.
- 9. CONFIRM THAT EACH HOLE IS PROPERLY ROUGHED AND DRY.
- 10. NO EPOXY INJECTION SHALL TAKE PLACE IN RAINY CONDITIONS.
- 11. EPOXY SHOULD BE VISIBLE AT THE TOP OF THE CORE HOLE AFTER INSTALLATION.
- 12. CONTRACTOR TO SUPPLY ONE PHOTO OF EACH ROUGHED AND CLEANED HOLE IN CLOSEOUT PHOTO PACKAGE.

TABLE 8.2 NUT ROTATION FROM SNUG-TIGHT CONDITION FOR TURN-OF-NUT PRETENSIONING a,b

	DISPOSITION OF OUTER FACE OF BOLTED PARTS				
BOLT LENGTH ^C	BOTH FACES NORMAL TO BOLT AXIS	ONE FACE NORMAL TO BOLT AXIS, OTHER SLOPED NOT MORE THAN 1:20 ^d	BOTH FACES SLOPED NOT MORE THAN 1:20 FROM NORMAL TO BOLT AXIS ^d		
NOT MORE THAN 4db	1/3 TURN	1/2 TURN	2/3 TURN		
MORE THAN 4d _b BUT NOT MORE THAN 8d _b	1/2 TURN	2/3 TURN	5/6 TURN		
MORE THAN 8d _b BUT NOT MORE THAN 12d _b	2/3 TURN	5/6 TURN	1 TURN		

O NUT ROTATION IS RELATIVE TO BOLT REGARDLESS OF THE ELEMENT (NUT OR BOLT) BEING TURNED. FOR REQUIRED NUT ROTATIONS OF 1/2 TURN AND LESS, THE TOLERANCE IS PLUS OR MINUS 30 DEGREES; FOR REQUIRED NUT ROTATIONS OF 2/3 TURN AND MORE, THE TOLERANCE IS PLUS OR MINUS 45 DEGREES.

SPECIFICATION FOR STRUCTURAL JOINTS USING ASTM A325 OR A490 BOLTS, JUNE 30, 2004 RESEARCH COUNCIL ON STRUCTURAL CONNECTIONS

INSTALLATION TORQUE REQUIRED FOR HOLLO BOLTS AND AJAX BOLTS:

- 1. HB12 HOLLO BOLT: 59 FT-LBS
- 2. HB16 HOLLO BOLT: 140 FT-LBS
- 3. HB20 HOLLO BOLT: 221 FT-LBS
- 4. M20 AJAX BOLT: 280 FT-LBS.

FIELD HOT WORK PLAN NOTES:

FOLLOWING GUIDELINES SHALL BE COMPLIED WITH:

- 1. CONTRACTOR'S RESPONSIBILITY TO COMPLETE A HOT WORK PLAN IF AWARDED PER CUSTOMER SPECIFICATIONS GUIDELINES FOR WELDING, CUTTING & SPARK PRODUCING WORK.
- 2. HAVE A FIRE PLAN APPROVED BY THE CUSTOMER AND THEIR SAFETY MANAGEMENT DEPT.
- CONTRACTOR MUST OBTAIN THE CONTACT INFO OF THE LOCAL FIRE DEPARTMENT AND THE 911 ADDRESS OF THE TOWER SITE BEFORE CONSTRUCTION.
- 4. CONTRACTOR SHALL MAKE SURE THAT CELL PHONE COVERAGE IS AVAILABLE IN THE TOWER SITE. IF CELL COVERAGE IS NOT AVAILABLE, AN IMMEDIATE AVAILABLE MEANS OF DIRECT COMMUNICATION WITH THE FIRE DEPARTMENT SHALL BE DETERMINED PRIOR TO CONSTRUCTION START.
- 5. ALL CONSTRUCTION SHALL BE PERFORMED UNDER WIND SPEED LESS THAN 10 MPH ON THE GROUND LEVEL. IF WIND SPEED INCREASE, CONTRACTOR MUST DETERMINE IF CONSTRUCTION SHALL BE DISCONTINUED.
- 6. FIRE SUPPRESSION EQUIPMENT MUST BE MADE AVAILABLE ON SITE AND READY TO USE.
- 7. CONTRACTOR SHALL ASSIGN A FIRE WATCHER TO PERFORM FIRE-FIGHTING DUTIES.
- 8. ALL WELDERS SHALL BE AWS OR STATE CERTIFIED. THEY MUST ALSO BE EXPERIENCED IN WELDING ON GALVANIZED MATERIALS.
- 9. IF IT IS POSSIBLE, ALL EXISTING COAX NEAR WELDING AREA SHALL BE TEMPORARILY MOVED AWAY FROM THE WELDING AREA BEFORE WELDING THE PLATES.
- 10. PLEASE REPORT ANY FIELD ISSUE TO TES @ 972-483-0607.

XTES

A CONGRUEX® COMPANY

1320 GREENWAY DRIVE, SUITE 600 IRVING, TX 75038 PHONE: (972) 483-0607



8051 CONGRESS AVENUE BOCA RATON, FL 33487 (800)-487-SITE

TES JOB NO: 148890

CUSTOMER SITE NO:
MO17428—A—SBA
CUSTOMER SITE NAME:
WEST BROADWAY
1201 WEST BROADWAY

COLUMBIA, MO 65203

STACEY E. HESSELBEIN, PE

CIVIL ENGINEERING LICENSE # 2019015881 TOWER ENGINEERING SOLUTIONS, LLC PROFESSIONAL ENGINEERING CORPORATION COA # E-2014025012

DRAW	N BY: DCR	CHECKED BY	: TA/JRL
REV.	DESCRIPTION	BY	DATE
<u> </u>	FIRST ISSUE	DCR	09/03/2
\wedge			
$ \overline{\wedge} $			
$\overline{\wedge}$			
$\overline{\wedge}$			

GENERAL NOTES

This drawing/document is the property of Tower Engineering Solutions, LLC. Information contained herein is considered confidential in nature and is to be used only for the specific site that it was intended for. Reproduction, transmission, publication or disclosure by any method is prohibited except by express written permission from Tower Engineering Solutions, LLC. Without exception, the information on this drawing/document remains the property of Tower Engineering Solutions, LLC.

SHEET NUMBER:

SHEET TITLE:

J**-**1

REV #:

^b APPLICABLE ONLY TO JOINTS IN WHICH ALL MATERIAL WITHIN THE GRIP IS STEEL.

WHEN THE BOLT LENGTH EXCEEDS 12d_b, THE REQUIRED NUT ROTATION SHALL BE DETERMINED BY ACTUAL TESTING IN A SUITABLE TENSION CALIBRATOR THAT SIMULATES THE CONDITIONS OF SOLIDLY FITTING STEEL.

^d BEVELED WASHER NOT USED.

NOTES:


- TEMPORARILY RELOCATE ANY EXISTING COAX ATTACHED TO THE MONOPOLE AND ANY OTHER MEMBERS WHERE OBSTRUCTION WITH THE PROPOSED MODIFICATION MAY OCCUR.
- 2. TEMPORARY RELOCATION OF EXISTING EQUIPMENT AROUND THE FOUNDATION MAY BE REQUIRED DURING CONSTRUCTION.

SCOPE OF WORK

- A. TEMPORARILY RELOCATE (3) EXISTING COMMSCOPE JAH4-65C-R4 PANEL ANTENNAS AT ±106'-0" ELEV. AND ASSOCIATED EQUIPMENT USING PROVIDED 3-SECTOR CHAIN MOUNT AND MOUNT PIPES (T1805KT & MP-1) BELOW NEW FLANGE AT ±60'-0" ELEV. (FINAL LOCATION TO BE DETERMINED BY AT&T)
 - SB. B. RE-ROUTE EXISTING (12) 1 5/8" & (4) RET COAX LINES FROM INSIDE THE POLE & INSTALL TEMPORARILY TO THE OUTSIDE OF THE POLE. SEE DETAIL 1 ON SHEET A-1A FOR AZIMUTHS. CONTRACTOR TO COORDINATE ALL ANTENNA RELOCATION WORK WITH AT&T.
- PREMOVE EXISTING (3) ± 30 " 0.D. X ± 10 '-0" CANISTER SHROUDS, TRANSITION CONE AND SPINE FROM ± 80 '-0" TO ± 110 '-0" ELEV.
- > INSTALL NEW HSS20.000X0.375 X 15'-0" A500 GR-B (42 KSI) POLE SECTION FROM \$\frac{\pmathbb{\pmathb{\pmathbb{\pmathbb{\pmathbb{\pmathbb{\pmathbb{\pmathbb{\pmathbb{
- NOTE: NEW MONOPOLE SECTION COLOR TO MATCH EXISTING TOWER COLOR.
- - CONTRACTOR TO MOVE EXISTING AT&T ANTENNAS AND ASSOCIATED EQUIPMENT BACK TO THE ORIGINAL ELEVATION AT ±106'-0" ELEV. CONTRACTOR TO COORDINATE ALL ANTENNA RELOCATION WORK WITH AT&T.
- 6 INSTALL NEW LIGHTNING ROD AT TOP OF THE NEW SECTION AND FIELD CUT IT DOWN IF REQUIRED TO MEET FAA APPROVAL. SEE DETAIL 2 ON SHEET A-1A.
- 7 APPLY FOUNDATION COATING, SEE NOTES ON SHEET A-1A.
- THE CONTRACTOR SHALL BE RESPONSIBLE FOR THE CLEAN-UP, REMOVAL AND DISPOSAL OF EXCESS MATERIALS USED AND REMOVED FROM THE STRUCTURE AT THE COMPLETION OF THE PROJECT.

INSTALLATION NOTE:

VERTICAL ALIGNMENT IS REQUIRED FOR ALL THE EXTENSION PROJECTS, TOWERS OR POLES

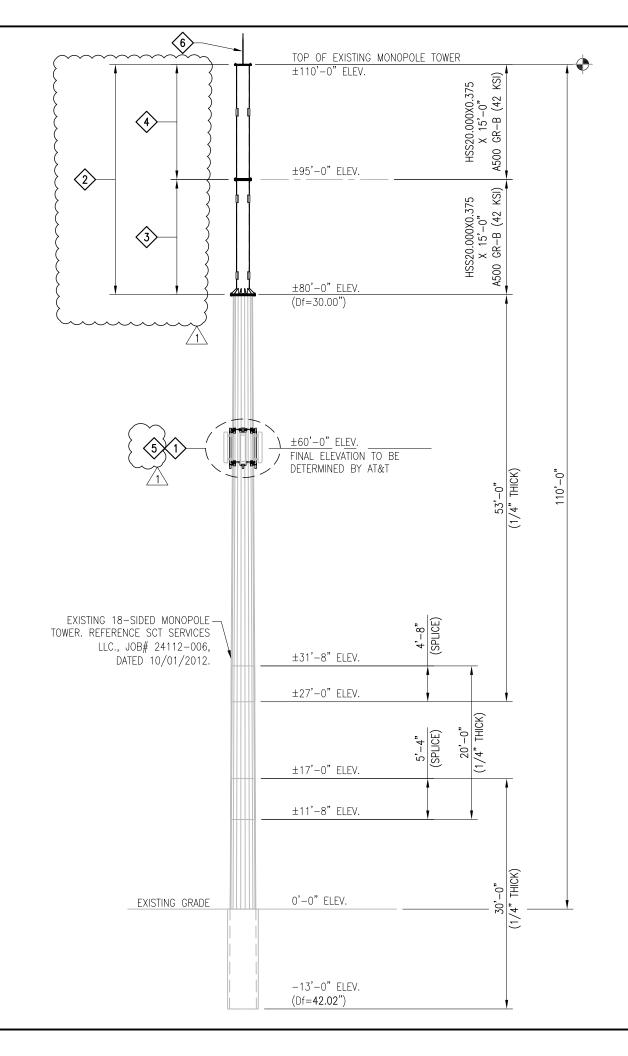



A CONGRUEX® COMPANY

1320 GREENWAY DRIVE, SUITE 600 IRVING, TX 75038 PHONE: (972) 483-0607



8051 CONGRESS AVENUE BOCA RATON, FL 33487 (800)-487-SITE

TES JOB NO: 148890

CUSTOMER SITE NO:
MO17428-A-SBA
CUSTOMER SITE NAME:
WEST BROADWAY

1201 WEST BROADWAY COLUMBIA, MO 65203

CIVIL ENGINEERING LICENSE # 2019015881
TOWER ENGINEERING SOLUTIONS, LLC
PROFESSIONAL ENGINEERING CORPORATION
COA # E-2014025012

DRAWN BY: DCR	CHECKED BY: TA/JRL
REV. DESCRIPTION FIRST ISSUE	BY DATE DCR 09/03/2
REVISED A A	DCR 10/17/2

SHEET TITLE:

TOWER PROFILE

This drawing/document is the property of Tower Engineering Solutions, LLC. Information contained herein is considered confidential in nature and is to be used only for the specific site that it was intended for. Reproduction, transmission, publication or disclosure by any method is prohibited except by express written permission from Tower Engineering Solutions, LLC. Without exception, the information on this drawing/document remains the property of Tower Engineering Solutions, LLC.


SHEET NUMBER:

A-1

REV #:

overight 2024 Tower Engineering Solutions 11.C.



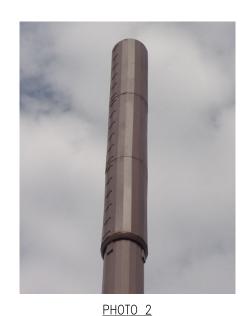

LIGHTNING ROD AS REQUIRED TO MEET FAA HEIGHT APPROVAL (116' A.G.L.)

LIGHTNING ROD W/ NON-FERROUS HARDWARE. INSTALL NEW LIGHTNING ROD TO THE TOP OF THE POLE.

> NEW EXTENSION-DETAIL 2


<u>PHOTO 1</u>

FOUNDATION COATING NOTES:

- 1. THE COATING MATERIALS SHALL BE LANCO WHITE ACRYLIC ELASTOMERIC COATING AND SEALER, OR HYDRO ARMOR COATING.
- 2. THE COATING CAN BE PLACED AT LEAST (2) DAYS AFTER THE PLACEMENT OF THE CONCRETE FOR FOUNDATION REINFORCEMENT, AND MINIMUM (4) DAYS FOR NEW FOUNDATION CONSTRUCTION.
- 3. THE CONCRETE SURFACE SHALL BE CLEAN AND DRY PRIOR TO THE APPLICATION OF THE COATING.
- 4. THE COATING SHALL BE APPLIED TO ALL THE SURFACES OF THE CONCRETE ABOVE THE GROUND AND 6"BELOW THE GRADE SURFACE IF APPLICABLE.
- 5. MINIMUM 30 MILS COATING IS REQUIRED.

CONTRACTOR TO FIELD CUT -

5/8"ø X 6'-0" COPPER CLAD-(SABRE PART# C30-086-006 OR EQUIVALENT).

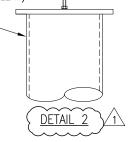

A CONGRUEX® COMPANY

1320 GREENWAY DRIVE, SUITE 600 IRVING, TX 75038 PHONE: (972) 483-0607



8051 CONGRESS AVENUE BOCA RATON, FL 33487 (800)-487-SITE

> TES JOB NO: 148890

CUSTOMER SITE NO: M017428-A-SBA CUSTOMER SITE NAME: WEST BROADWAY 1201 WEST BROADWAY

STACEY E. HESSELBEIN, PE
CIVIL ENGINEERING LICENSE # 2019015881
TOWER ENGINEERING SOLUTIONS, LLC
PROFESSIONAL ENGINEERING CORPORATION
COA # E-2014025012

COLUMBIA, MO 65203

DRAWN BY: DCR	CHECKED BY: TA/JRL
REV. DESCRIPTION	BY DATE
<u> </u>	DCR 09/03/2
1 REVISED	DCR 10/17/2
\triangle	
Δ	
\triangle	

ADDITIONAL DETAILS


This drawing/document is the property of Tower Engineering Solutions, LLC. Information contained herein is considered confidential in nature and is to be used only for the specific site that it was intended for. Reproduction, transmission, publication or disclosure by any method is prohibited except by express written permission from Tower Engineering Solutions, LLC. Without exception, the information on this drawing/document remains the property of Tower Engineering Solutions, LLC.


SHEET NUMBER:


SHEET TITLE:

REV #:

A-1A

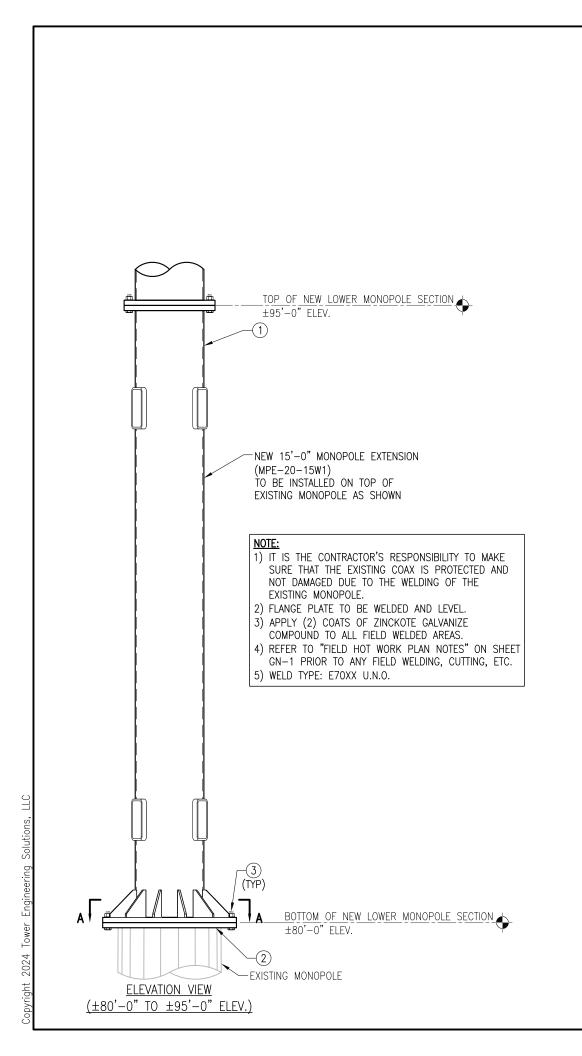

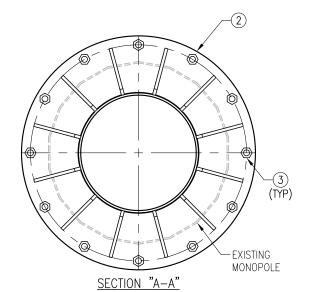


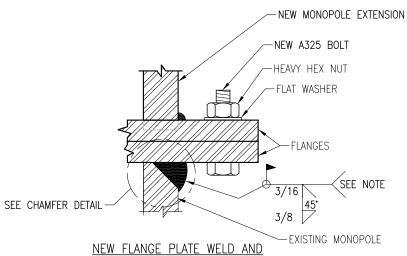

BOLT INSTALLATION DETAIL

TIGHTEN FLANGE BOLTS PER NOTES ON SHEET GN-1. TABLE 8.2.

FIELD NOTE:
DO NOT USE A LOCKWASHER WITH THIS CONNECTION.

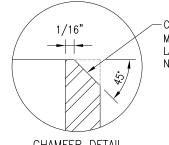

CHAMFER EDGE OF EXISTING MONOPOLE TOP WITH A 1/16" LANDING BEFORE WELDING ON NEW FLANGE PLATE.

CHAMFER DETAIL

3	12		BOLT 1" X 4 3/4" A325 W/ NUT-FW EA.
2	1	FP-20	FLANGE PLATE PL 1 1/2" X 3'-3" DIA A572-50
1	1	MPE-20-15W1	MONOPOLE EXTENSION WELDMENT (PIPE HSS20.000X0.375 X 15'-0") (42 KSI) A500 GR-B
ITEM NO	QTY.	PART NO.	DESCRIPTION



A CONGRUEX® COMPANY

1320 GREENWAY DRIVE, SUITE 600 IRVING, TX 75038 PHONE: (972) 483-0607



8051 CONGRESS AVENUE BOCA RATON, FL 33487 (800)-487-SITE

> TES JOB NO: 148890

CUSTOMER SITE NO: M017428-A-SBA CUSTOMER SITE NAME: WEST BROADWAY 1201 WEST BROADWAY

COLUMBIA, MO 65203

STACEY E. HESSELBEIN, PE
CIVIL ENGINEERING LICENSE # 2019015881
TOWER ENGINEERING SOLUTIONS, LLC
PROFESSIONAL ENGINEERING CORPORATION
COA # E-2014025012

DRAWN BY: DCR	CHECKED BY: TA/JRL
REV. DESCRIPTION	BY DATE
<u> </u>	DCR 09/03/24
\land	
$\overline{\triangle}$	
\triangle	
\triangle	

SHEET TITLE:


MONOPOLE SECTION INSTALLATION DETAILS


This drawing/document is the property of Tower Engineering Solutions, LLC. Information contained herein is considered confidential ir nature and is to be used only for the specific site that it was intended for. Reproduction, transmission, publication or disclosure by any method is prohibited except by express written permission from Tower Engineering Solutions, LLC. Without exception, the information on this drawing/document remains the property of Tower Engineering Solutions, LLC.


SHEET NUMBER:


A-2

REV #:

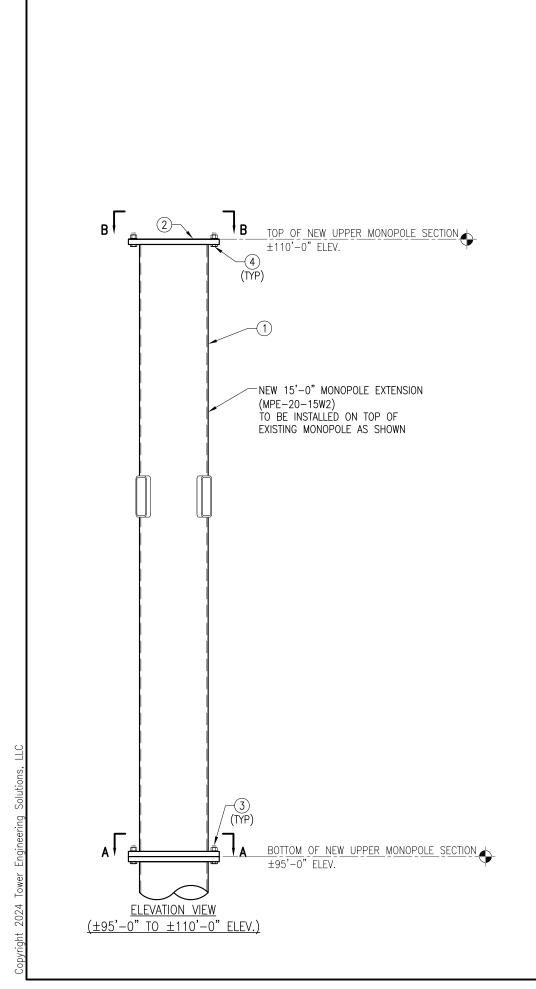

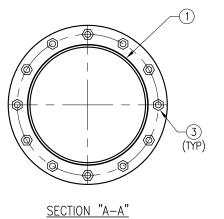

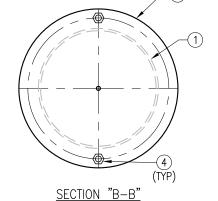

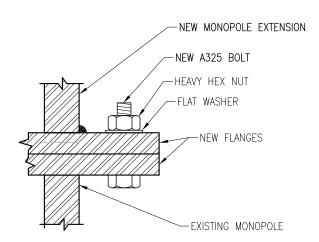

NEW FLANGE PLATE WELD AND BOLT INSTALLATION DETAIL NOTE:

TIGHTEN FLANGE BOLTS PER NOTES ON SHEET GN-1. TABLE 8.2.

FIELD NOTE:
DO NOT USE A LOCKWASHER WITH
THIS CONNECTION.

4	2		BOLT 1" X 3 1/2" A325 W/ NUT-FW EA.
3	12		BOLT 1" X 4 3/4" A325 W/ NUT-FW EA.
2	1	CPL-20	TOP CAP PLATE PL 3/16" X 2'-2 1/2" DIA A36
1	1	MPE-20-15W2	MONOPOLE EXTENSION WELDMENT (PIPE HSS20.000X0.375 X 15'-0") (42 KSI) A500 GR-B
ITEM NO.	QTY.	PART NO.	DESCRIPTION



A CONGRUEX° COMPANY

1320 GREENWAY DRIVE, SUITE 600 IRVING, TX 75038 PHONE: (972) 483-0607



8051 CONGRESS AVENUE BOCA RATON, FL 33487 (800)-487-SITE

TES JOB NO: 148890

CUSTOMER SITE NO:
MO17428-A-SBA
CUSTOMER SITE NAME:
WEST BROADWAY
1201 WEST BROADWAY
COLUMBIA, MO 65203

STACEY E. HESSELBEIN, PE
CIVIL ENGINEERING LICENSE # 2019015881
TOWER ENGINEERING SOLUTIONS, LLC
PROFESSIONAL ENGINEERING CORPORATION
COA # E-2014025012

CHECKED BY: TA/JRL
BY DATE
DCR 09/03/24

MONOPOLE SECTION INSTALLATION DETAILS

This drawing/document is the property of Tower Engineering Solutions, LLC. Information contained herein is considered confidential in nature and is to be used only for the specific site that it was intended for. Reproduction, transmission, publication or disclosure by any method is prohibited except by express written permission from Tower Engineering Solutions, LLC. Without exception, the information on this drawing/document remains the property of Tower Engineering Solutions, LLC.

SHEET NUMBER:

SHEET TITLE:

REV #:

A-3



SITE NUMBER: MO17428-A-02 SITE NAME: WEST BROADWAY

T-MOBILE SITE NAME: SBA BROADWAY COLUMBIA

T-MOBILE SITE NUMBER: MO08134B

T-MOBILE COLLOCATION ON A NEW 85'6" MONOPOLE TOWER,

REPLACING THE EXISTING CANISTER STRUCTURE

201 WEST BROADWAY COLUMBIA, MO 65203 (BOONE COUNTY)







SITE #: MO17428-A-02

SITE NAME: WEST BROADWAY ADDRESS: 201 WEST BROADWAY COLUMBIA, MO 65203










SITE #: MO17428-A-02

SITE NAME: WEST BROADWAY ADDRESS: 201 WEST BROADWAY COLUMBIA, MO 65203

COUNTY: BOONE

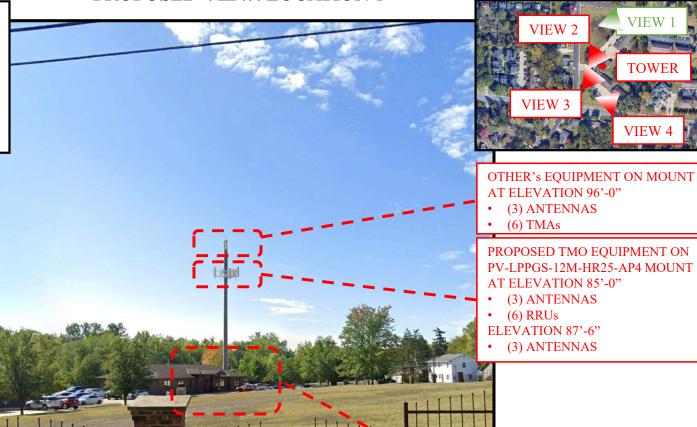

- (2) CABINET (NOT VISIBLE)
- ICE BRIDGE (NOT VISIBLE)








SITE #: MO17428-A-02

SITE NAME: WEST BROADWAY ADDRESS: 201 WEST BROADWAY COLUMBIA, MO 65203

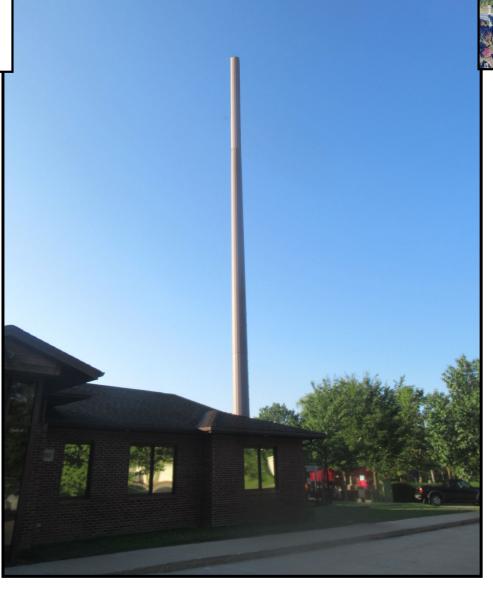










SITE #: MO17428-A-02

SITE NAME: WEST BROADWAY ADDRESS: 201 WEST BROADWAY COLUMBIA, MO 65203

COUNTY: BOONE

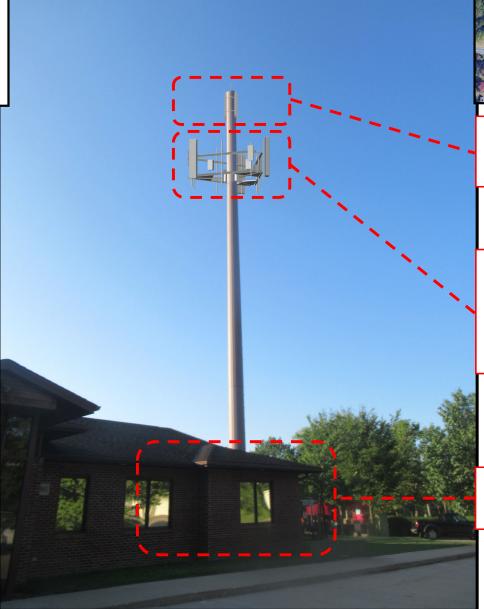



OTHER'S EQUIPMENT ON MOUNT AT ELEVATION 96'-0"

- (3) ANTENNAS
- (6) TMAs

PROPOSED TMO EQUIPMENT ON PV-LPPGS-12M-HR25-AP4 MOUNT AT ELEVATION 85'-0"

- (3) ANTENNAS
- (6) RRUs

ELEVATION 87'-6"

• (3) ANTENNAS

- (2) CABINET (NOT VISIBLE)
- ICE BRIDGE (NOT VISIBLE)







SITE #: MO17428-A-02

SITE NAME: WEST BROADWAY ADDRESS: 201 WEST BROADWAY COLUMBIA, MO 65203










SITE #: MO17428-A-02

SITE NAME: WEST BROADWAY ADDRESS: 201 WEST BROADWAY COLUMBIA, MO 65203

COUNTY: BOONE

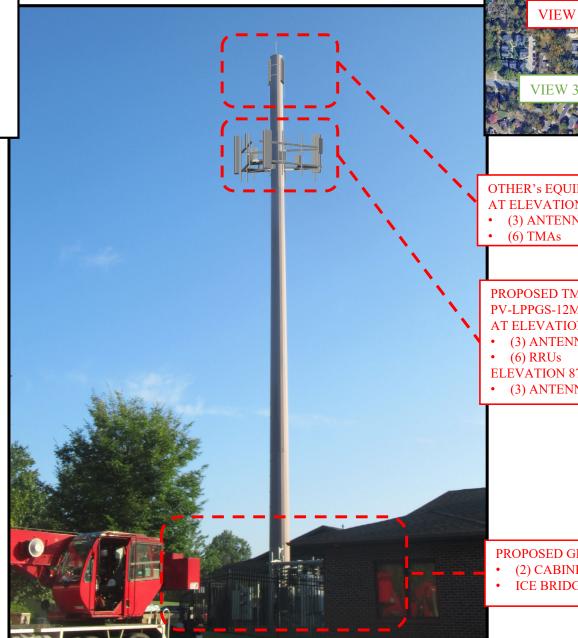



OTHER'S EQUIPMENT ON MOUNT AT ELEVATION 96'-0"

• (3) ANTENNAS

PROPOSED TMO EQUIPMENT ON PV-LPPGS-12M-HR25-AP4 MOUNT AT ELEVATION 85'-0"

- (3) ANTENNAS
- ELEVATION 87'-6"
- (3) ANTENNAS

- (2) CABINET (NOT VISIBLE)
- ICE BRIDGE (NOT VISIBLE)








SITE #: MO17428-A-02

SITE NAME: WEST BROADWAY ADDRESS: 201 WEST BROADWAY COLUMBIA, MO 65203

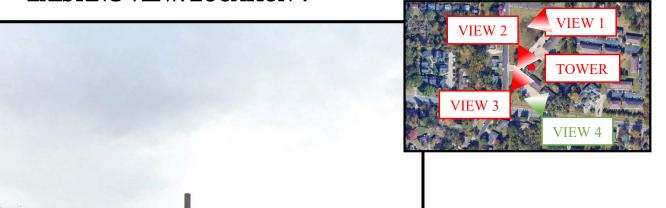







SITE #: MO17428-A-02

SITE NAME: WEST BROADWAY ADDRESS: 201 WEST BROADWAY COLUMBIA, MO 65203

COUNTY: BOONE



AT ELEVATION 96'-0"

- (3) ANTENNAS
- (6) TMAs

PROPOSED TMO EQUIPMENT ON PV-LPPGS-12M-HR25-AP4 MOUNT AT ELEVATION 85'-0"

- (3) ANTENNAS
- (6) RRUs

ELEVATION 87'-6"

• (3) ANTENNAS

- (2) CABINET (NOT VISIBLE)
- ICE BRIDGE (NOT VISIBLE)

